COLLECTOR STREET LIGHTING IMPROVEMENTS ASH RD, ILLINOIS BLVD, AND THACKER ST VILLAGE OF HOFFMAN ESTATES

MAYOR WILLIAM D. McLEOD

VILLAGE MANAGER ERIC PALM


TRUSTEES
KAREN V. MILLS
ANNA NEWELL
GARY J. PILAFAS
GARY G. STANTON
KAREN J. ARNET
PATRICK KINNANE

ASH ROAD BETWEEN -HIGGINS ROAD AND **GOLF ROAD** PROJECT LOCATION MAP W Berkley Ln ILLINOIS BOULEVARD BETWEEN -E Schaumburg Rd Schaumburg

THACKER STREET BETWEEN ——
ILLINOIS BOULEVARD AND

ROSELLE ROAD

SCHAUMBURG ROAD AND ROSELLE ROAD

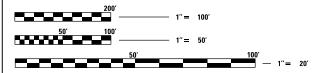


FULL SIZE PLANS HAVE BEEN PREPARED USING STANDARD ENGINEERING SCALES, REDUCED SIZED PLANS WILL NOT CONFORM TO STANDARD SCALES. IN MAKING MEASUREMENTS ON REDUCED PLANS, THE ABOVE SCALES MAY BE USED

CONTACT INFORMATION
J.U.L.I.E. 800.892.0123
Hoffman Estates
Public Works 847,490.6800
Police 847.781.2800
Fire 847.843.4825

Emergency 911

1	COVER
2	LEGEND, GENERAL NOTES AND SOQ
3 – 4	ALIGNMENT AND TIES
5 – 10	PROPOSED LIGHTING PLAN
11	ASH RD LIGHTING CONTROLLER ONE-LINE DIAGRAM
12	ILLINOIS BLVD & THACKER ST LIGHTING CONTROLLER ONE-LINE DIAGRAM
13 – 19	LIGHTING DETAILS
20	VILLAGE DETAILS
21 – 22	MOT DETAILS
00 04	CIVIL DETAILS
23 – 24	CIVIL DETAILS

INDEX OF SHEETS

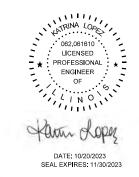




SHEET 1 OF 24

LIGHTING IMPROVEMENTS

OCTOBER 20, 2023


LIGHTING GENERAL NOTES

- THE LOCATION OF BURIED AND ABOVE GROUND UTILITIES SHOWN ARE APPROXIMATE AND ARE SHOWN FOR INFORMATION ONLY. REPOUTING, DISCONNECTION, RELOCATION, PROTECTION ETC., OF ANY UTILITIES MUST BE COORDINATED BETWEEN THE CONTRACTOR, UTILITY COMPANY, AND OWNER. THE CONTRACTOR SHALL FIELD VERIFY THE EXACT LOCATION OF ALL UNDERGROUND UTILITIES BASED ON UTILITY/JULIE MARKINGS PRIOR TO BEGINNING CONSTRUCTION.
- . THE LOCATIONS OF EXISTING LIGHTING FACILITIES SHOWN ON THE PLANS ARE APPROXIMATE. THE CONTRACTOR SHALL FIELD VERIFY EXACT LOCATIONS.
- BEFORE INSTALLING LIGHT STANDARDS NEAR OVERHEAD AND UNDERGROUND ELECTRIC UTILITIES THE CONTRACTOR SHALL CALL ELECTRIC UTILITY COMPANY FOR LOCATION APPROVAL AND MINIMUM CLEARANCE REQUIREMENTS.
- 4. ALL WORK SHALL BE IN ACCORDANCE WITH THE LATEST EDITIONS OF THE FOLLOWING SPECIFICATIONS:
 - A. STANDARD SPECIFICATIONS FOR ROAD AND BRIDGE CONSTRUCTION, AS PREPARED BY IDOT, ALSO REFERRED TO AS THE "STANDARD SPECIFICATIONS"
 - B. NATIONAL ELECTRIC CODE (NEC)
 - ${\sf C.\ LOCAL\ CODES\ AND\ STANDARDS}$
 - D. COM ED STANDARDS
- THE CONTRACTOR SHALL BE SOLELY RESPONSIBLE FOR JOB SITE SAFETY AS WELL AS SUPERVISION/DIRECTION AND MEANS/METHODS OF CONSTRUCTION.
- 5. LIGHT POLE LOCATIONS SHALL COMPLY WITH THE MINIMUM CLEAR WIDTHS FOR AN ACCESSIBLE ROUTE FOR SIDEWALKS PER THE CURRENT AMERICAN DISABILITIES ACT (ADA) REQUIREMENTS AND COMPLY WITH IDOT BDE CHAPTER 17-4.03.
- NO LIGHT POLE SHALL BE ERECTED UNTIL THE CONCRETE FOUNDATION HAS CURED PER ARTICLE 1020.13 OF THE STANDARD SPECIFICATIONS, AS REQUIRED.
- 8. THE CONTRACTOR SHALL INSTALL LUMINAIRES LEVEL WITH OPTICS SET PERPENDICULAR TO THE CENTERLINE OF THE ROADWAY OR SIDEWALK/PATHWAY.
- THE CONTRACTOR SHALL BE RESPONSIBLE FOR THE ESTABLISHMENT OF THE TOP OF FOUNDATION ELEVATION WITH FINISH GRADE.
- ALL PROPOSED LIGHTING UNITS SHALL BE LABELED ACCORDING TO THE STANDARD SPECIFICATIONS, UNLESS OTHERWISE NOTED.
- 11. UNDERGROUND CABLES SHALL BE DISCONNECTED AND REMOVED FROM CONDUITS TO BE ABANDONED.
- 12. UNDERGROUND CONDUITS TO BE ABANDONED SHALL BE REMOVED TO A MINIMUM OF 2 FT BELOW GRADE.
- CONTRACTOR SHALL USE METAL FOUNDATIONS WHEREVER POSSIBLE. IF UTILITIES PROHIBIT THE USE OF A METAL FOUNDATION, THAN A CONCRETE OFFSET FOUNDATION SHALL BE USED INSTEAD. CONTRACTOR SHALL COORDINATE THIS WORK WITH THE ENGINEER.
- 14. THE CONTRACTOR SHALL PROTECT TREES AS DIRECTED BY THE ENGINEER WITHIN AND ADJACENT TO THE CONSTRUCTION SITE DURING CONSTRUCTION OPERATIONS.
- 15. THE CONTRACTOR SHALL MAINTAIN ACCESS TO ALL DRIVEWAYS THROUGHOUT THE RECONSTRUCTION LIMITS AT ALL TIMES. IF DRIVEWAY ACCESS MUST BE RESTRICTED, THE CONTRACTOR SHALL NOTIFY THE VILLAGE IN WRITING 72 HOURS IN ADVANCE.
- 16. EMERGENCY VEHICLES SHALL HAVE ACCESS ALONG ALL COLLECTOR STREETS AT ALL TIMES.
- 17. AT THE END OF EACH WORK DAY THE CONTRACTOR SHALL BACKFILL OR COVER ALL OPEN EXCAVATIONS TO PROVIDE PROTECTION FOR THE PUBLIC DURING NON-WORKING HOURS.
- 8. CONTRACTOR MAY OBTAIN A VILLAGE WATER METER FOR FREE WATER USAGE ON THIS JOB. THE WATER METER CAN BE OBTAINED BY VILLAGE PUBLIC WORKS DEPARTMENT FOR A \$775 FEE DEPOSIT.
- 19. RESTORATION QUANTITIES PROVIDED ARE BASED ON UTILITY ATLAS INFORMATION RECEIVED DURING DESIGN. CONTRACTOR SHALL FIELD VERIFY ALL UTILITY CONFLICTS AND NOTIFY THE VILLAGE AND ENGINEER OF ANY DISCREPANCIES IN QUANTITIES BASED ON UTILITY CONFLICTS ENCOUNTERED DURING CONSTRUCTION.

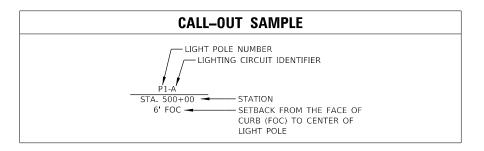

SUMMARY OF QUANTITIES

ITEM NO.	ITEM DESCRIPTION	UNITS	TOTAL QUANTITIES
20101100	TREE TRUNK PROTECTION	EACH	16
20101300	TREE PRUNING (1 TO 10 INCH DIAMETER)	EACH	8
20101350	TREE PRUNING (OVER 10 INCH DIAMETER)	EACH	3
20101400	NITROGEN FERTILIZER NUTRIENT	POUND	15
20101500	PHOSPHORUS FERTILIZER NUTRIENT	POUND	15
20101600	POTASSIUM FERTILIZER NUTRIENT	POUND	15
20101700	SUPPLEMENTAL WATERING	UNIT	2
20800150	TRENCH BACKFILL	CUYD	56
21101625	TOPSOIL FURNISH AND PLACE, 6"	SQ YD	801
25000100	SEEDING, CLASS 1	ACRE	1
25100630	EROSION CONTROL BLANKET	SQ YD	801
35101600	AGGREGATE BASE COURSE, TYPE B 4"	SQ YD	238
42300200	PORTLAND CEMENT CONCRETE DRIVEWAY PAVEMENT, 6 INCH	SQ YD	43
42400200	PORTLAND CEMENT CONCRETE SIDEWALK 5 INCH	SQ FT	688
42400800	DETECTABLE WARNINGS	SQ FT	198
44000500	COMBINATION CURB AND GUTTER REMOVAL	FOOT	468
44000600	SIDEWALK REMOVAL	SQ FT	688
44201761	CLASS D PATCHES, TYPE I, 10 INCH	SQ YD	48
60603800	COMBINATION CONCRETE CURB AND GUTTER, TYPE B-6.12	FOOT	468
67100100	MOBILIZATION	L SUM	1
80400100	ELECTRIC SERVICE INSTALLATION	EACH	2
80400200	ELECTRIC UTILITY SERVICE CONNECTION	L SUM	1
81028210	UNDERGROUND CONDUIT, GALVANIZED STEEL, 2 1/2" DIA.	FOOT	1205
81028240	UNDERGROUND CONDUIT, GALVANIZED STEEL, 4" DIA.	FOOT	180
81400730	HANDHOLE, COMPOSITE CONCRETE	EACH	3
81603037	UNIT DUCT, 600V, 2-1C NO.6, 1/C NO.6 GROUND, (XLP-TYPE USE), 1 1/4" DIA. POLYETHYLENE	FOOT	846
81603096	UNIT DUCT, 600V, 4-1C NO.8, 1/C NO.8 GROUND, (XLP-TYPE USE), 1 1/4" DIA. POLYETHYLENE	FOOT	2198
81603100	UNIT DUCT, 600V, 4-1C NO.6, 1/C NO.6 GROUND, (XLP-TYPE USE), 1 1/4" DIA. POLYETHYLENE	FOOT	9408
81603105	UNIT DUCT, 600V, 4-1C NO.4, 1/C NO.4 GROUND, (XLP-TYPE USE), 1 1/2" DIA. POLYETHYLENE	FOOT	707
81702150	ELECTRIC CABLE IN CONDUIT, 600V (XLP-TYPE USE) 1/C NO. 2	FOOT	873
82110006	LUMINAIRE, LED, ROADWAY, OUTPUT DESIGNATION F	EACH	64
82500350	LIGHTING CONTROLLER, BASE MOUNTED, 240VOLT, 100AMP	EACH	2
83006300	LIGHT POLE, ALUMINUM, 30 FT. M.H., 8 FT. MAST ARM	EACH	64
83600352	LIGHT POLE FOUNDATION, METAL, 11 1/2" BOLT CIRCLE, 8 5/8" X 6'	EACH	63
84200500	REMOVAL OF LIGHTING UNIT, SALVAGE	EACH	4
84200804	REMOVAL OF POLE FOUNDATION	EACH	4
89502300	REMOVE ELECTRIC CABLE FROM CONDUIT	FOOT	2379
XX006766	GFI RECEPTACLE BOX, 120V	EACH	1
X7010216	TRAFFIC CONTROL AND PROTECTION, (SPECIAL)	L SUM	1
X8210405	LUMINAIRE SHIELD	EACH	15
X8360215	LIGHT POLE FOUNDATION, 24" DIAMETER, OFFSET	FOOT	18
XX003338	TEST HOLE	EACH	55
Z0033026	MAINTENANCE OF EXISTING LIGHTING SYSTEM COMPLETE	L SUM	1

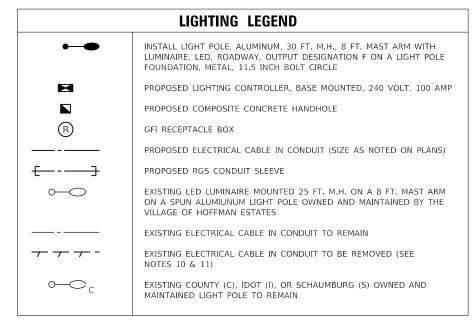


	ABBREVIATIONS
ABBREVIATION	DESCRIPTION
AC	ALTERNATING CURRENT
A/C	AERIAL CABLE
B.O.C.	BACK OF CURB
СВ	CIRCUIT BREAKER
CKT	CIRCUIT
CP	CONTROL POINT
СТ	CURRENT TRANSFORMER
DA	DAVIT ARM
DC	DIRECT CURRENT
DIA	DIAMETER
DP	DISTRIBUTION PANEL
E	EXISTING UNIT TO REMAIN
ECA	ELECTRIC CABLE ASSEMBLY
E.O.P.	EDGE OF PAVEMENT
F.O.C.	FACE OF CURB
F.O.C.	FEET OR FOOT
FU	FUSE
GALV	
GALV	GALVANIZED GROUND
JB	JUNCTION BOX
KVA	KILOVOLT-AMPERE
KW	KILOWATT
MA	MAST ARM
MC	MULTI-CONDUCTOR
M.H.	MOUNTING HEIGHT
MW	MESSANGER WIRE
NO #	NUMBER
N.T.S.	NOT TO SCALE
P	PROPOSED
PB	PUSH BUTTON
PNL	PANEL
PVC	POLYVINYL CHLORIDE
PVCC RGC	PVC COATED RIGID GALVANIZED STEEL
PT	POTENTIAL TRANSFORMER
R	EXISTING UNIT TO BE REMOVED
RR	EXISTING UNIT TO BE REMOVED AND REINSTALLED
RECP	RECEPTACLE
RGS	RIGID GALVANIZED STEEL
SEL SW	SELECTOR SWITCH
SPARE	SPARE
SPACE	SPACE
SS	STAINLESS STEEL
STA	STATION
T/F	TOP OF FOUNDATION
UD	UNIT DUCT
U.N.O.	UNLESS OTHERWISE NOTED
WP	WOOD POLE
XFMR	TRANSFORMER
LTFM	LIQUID TIGHT FLEXIBLE METALLIC





USER NAME = Electrical	DESIGNED - KL	REVISED -
	DRAWN - MLB	REVISED -
PLOT SCALE = 80.0000 ' / in.	CHECKED - JV	REVISED -
PLOT DATE = 10/20/2023	DATE - 10/13/2023	REVISED -


SCALE: N.T.S.

ROPOSED COLLECTOR STREET LIGHTING GENERAL NOTES AND LEGEND		SECTION	COUNTY	TOTAL SHEETS	SHEET NO.
		N/A	соок	24	2
GENERAL NOTES AND LEGEND	CONTRACT NO.			ΓNO.	N/A
HEET 1 OF 1 SHEETS STA TO STA		TILLINOIS FED /	ID PROJECT		

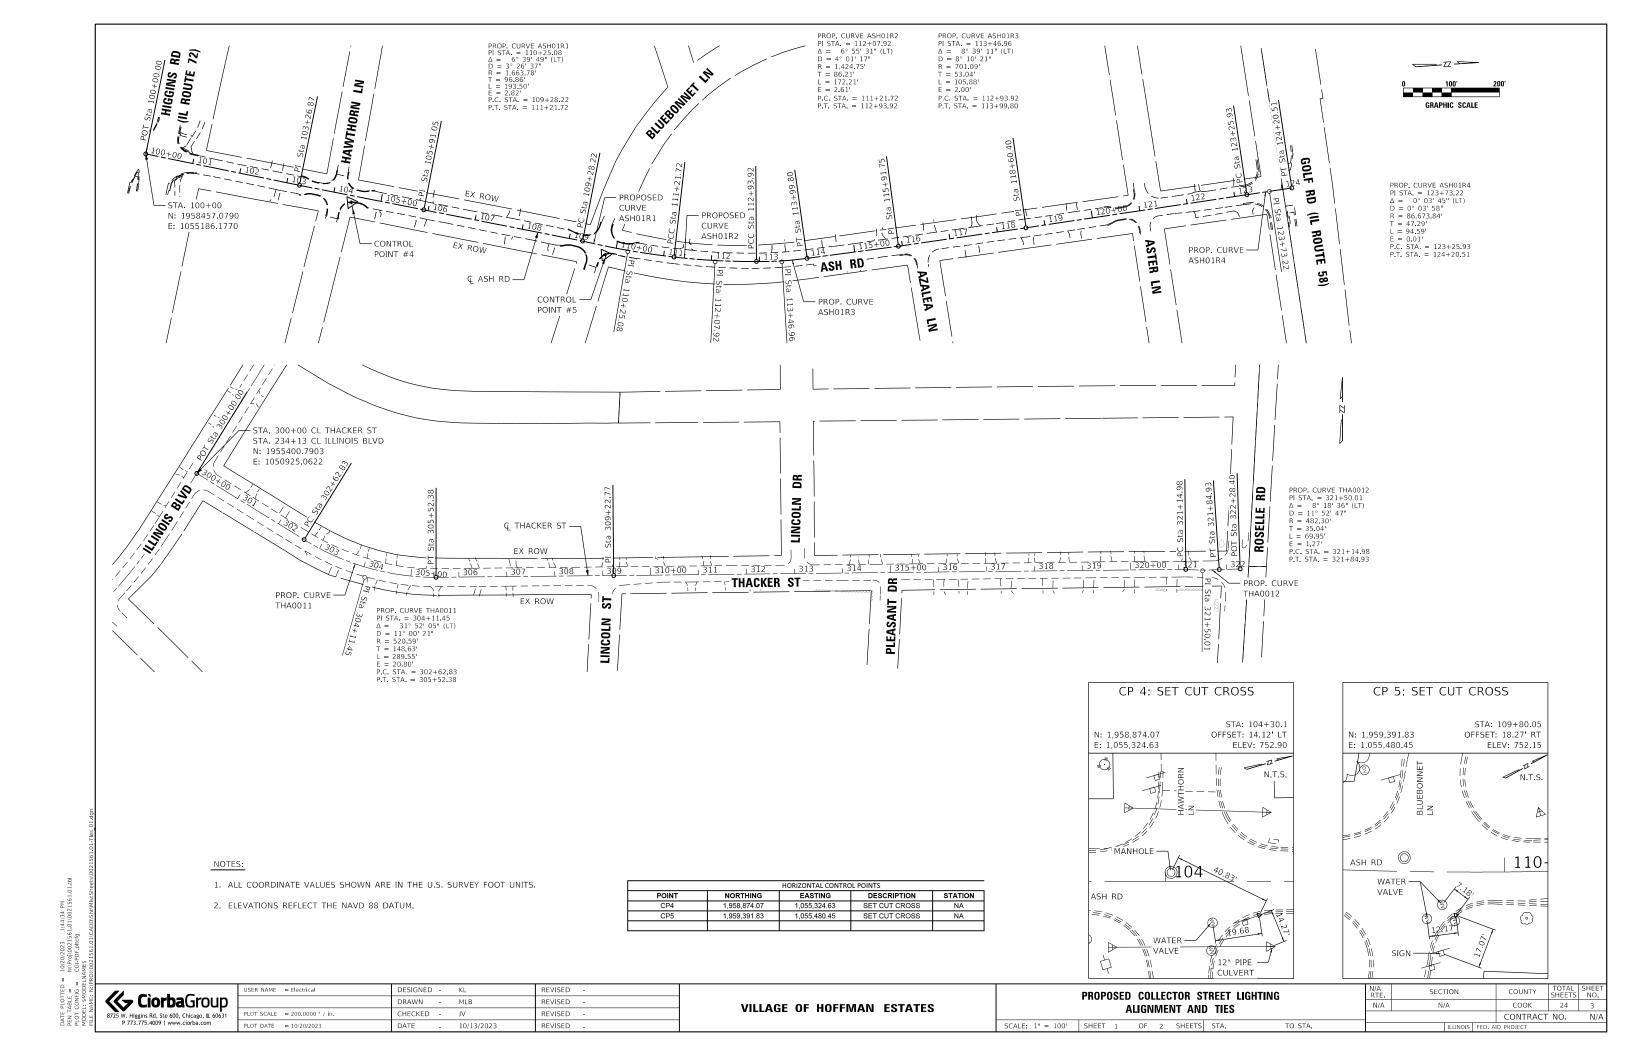

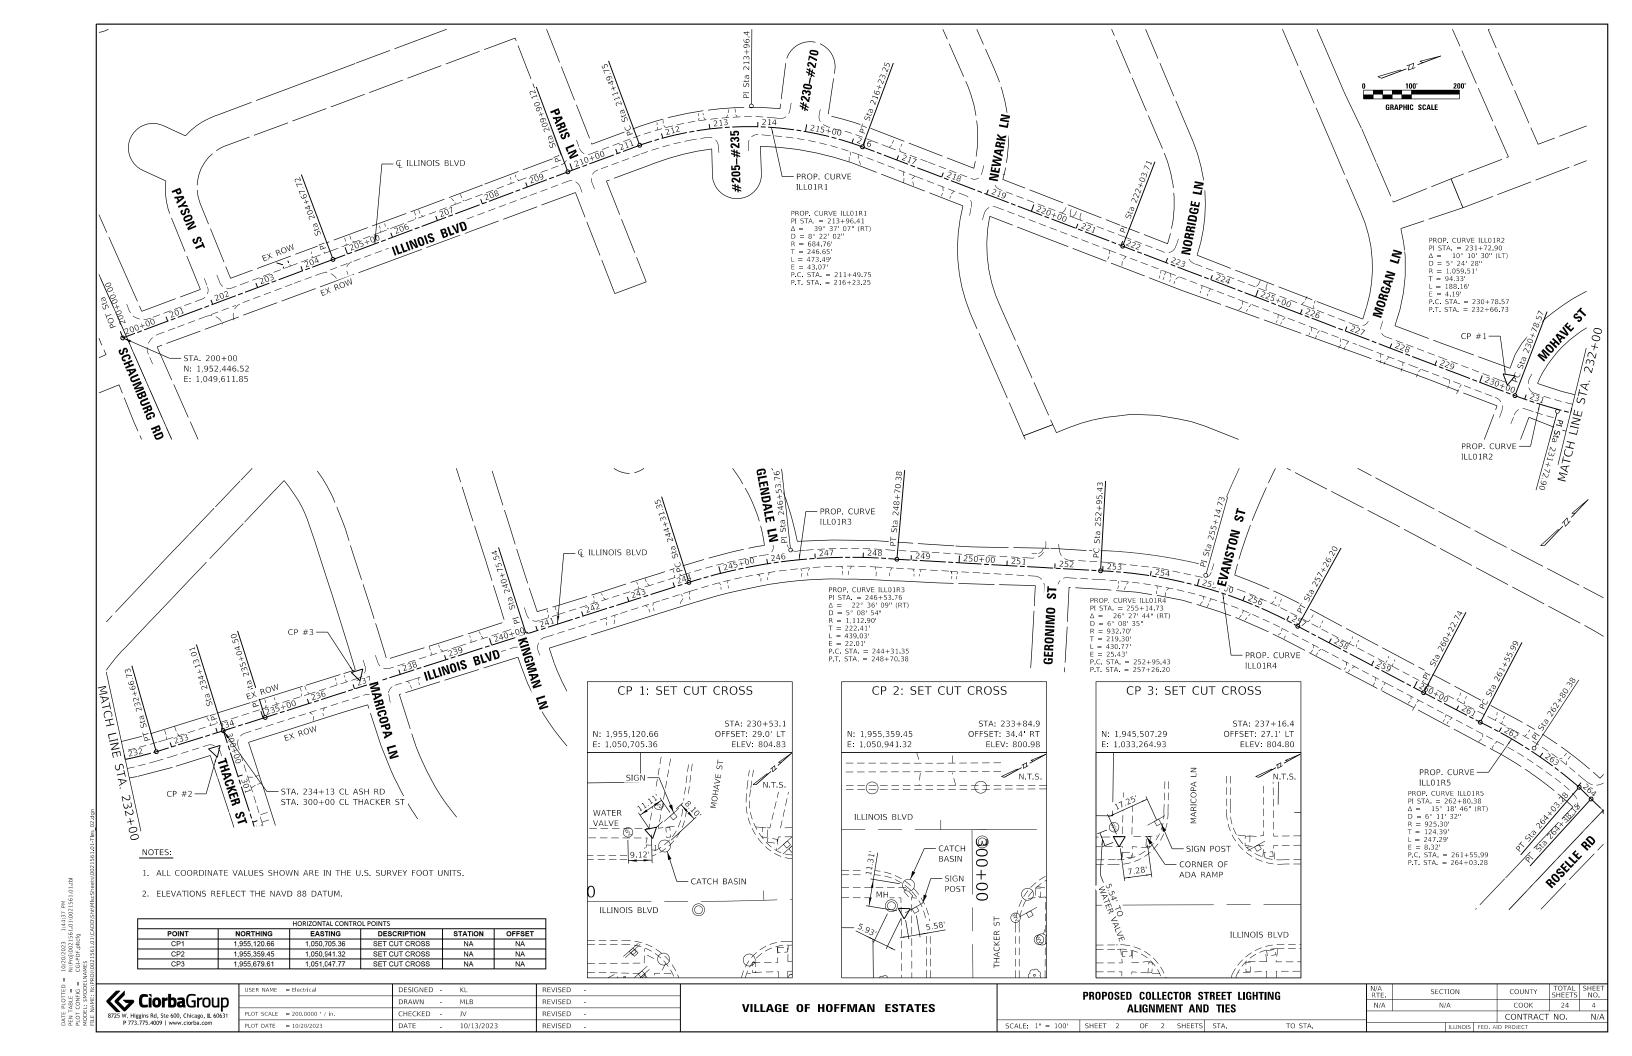

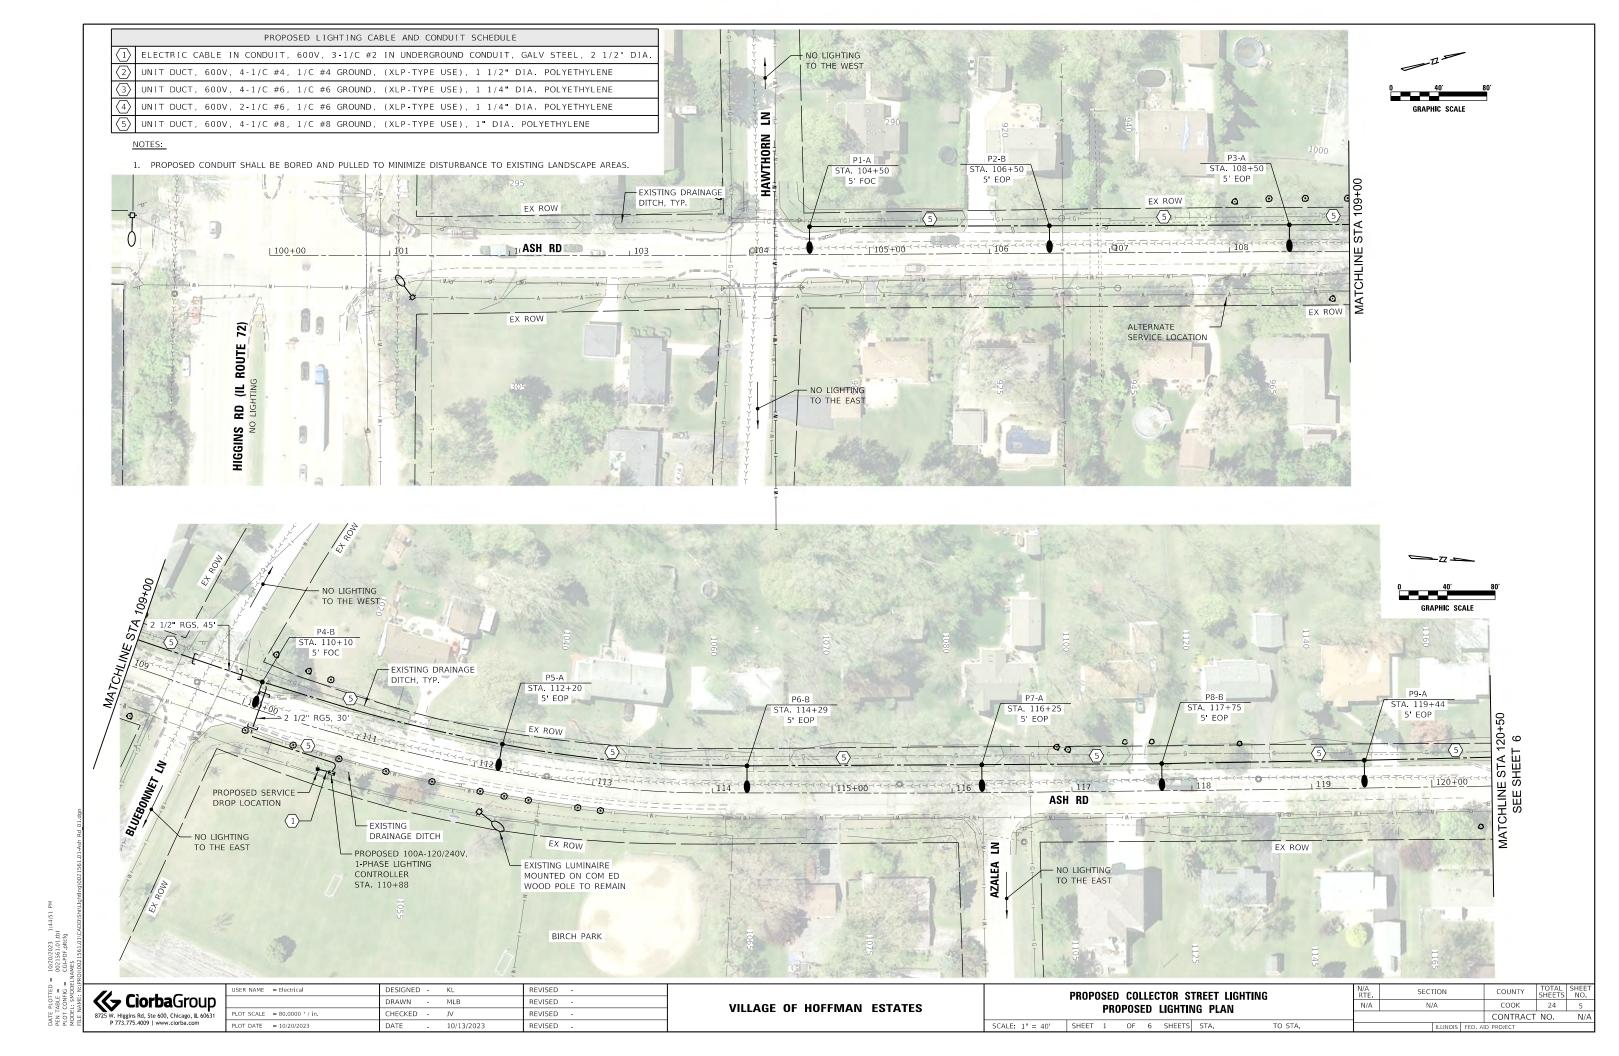

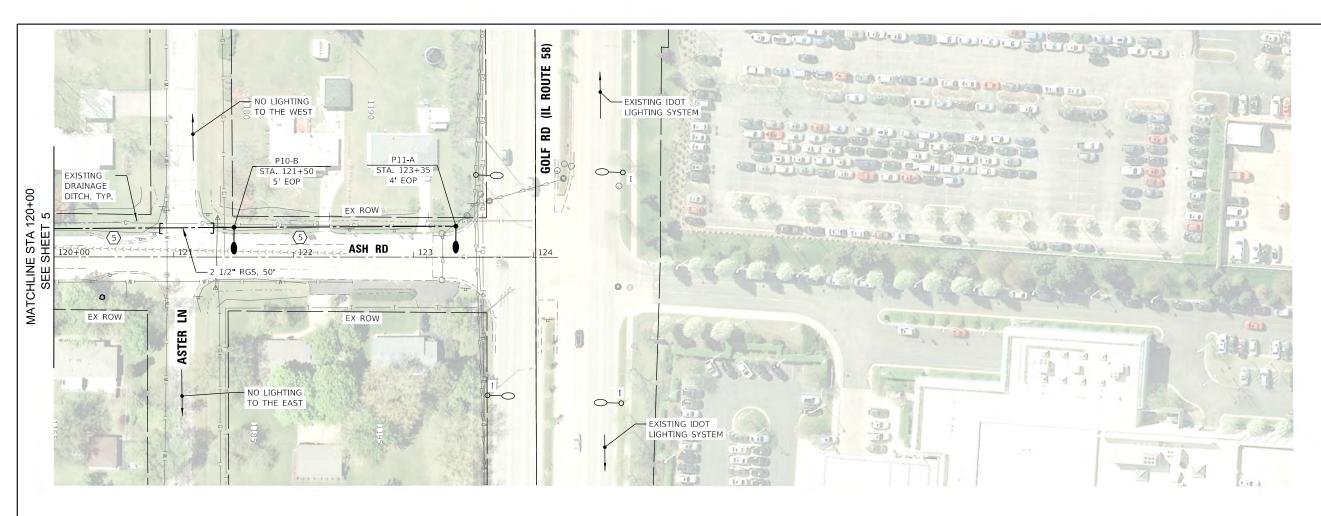



NOTES:


1. PROPOSED CONDUIT SHALL BE BORED AND PULLED TO MINIMIZE DISTURBANCE TO EXISTING LANDSCAPE AREAS.

	PROPOSED LIGHTING CABLE AND CONDUIT SCHEDULE
$\langle 1 \rangle$	ELECTRIC CABLE IN CONDUIT, 600V, 3-1/C #2 IN UNDERGROUND CONDUIT, GALV STEEL, 2 1/2" DIA.
2	UNIT DUCT, 600V, 4-1/C #4, 1/C #4 GROUND, (XLP-TYPE USE), 1 1/2" DIA. POLYETHYLENE
(3)	UNIT DUCT, 600V, 4-1/C #6, 1/C #6 GROUND, (XLP-TYPE USE), 1 1/4" DIA. POLYETHYLENE
$\langle 4 \rangle$	UNIT DUCT, 600V, 2-1/C #6, 1/C #6 GROUND, (XLP-TYPE USE), 1 1/4" DIA. POLYETHYLENE
$\langle 5 \rangle$	UNIT DUCT, 600V, 4-1/C #8, 1/C #8 GROUND, (XLP-TYPE USE), 1" DIA. POLYETHYLENE



	USER NAME = Electrical	DESIGNED	-	KL	REVISED -
)		DRAWN	-	MLB	REVISED -
	PLOT SCALE = 80.0000 / in.	CHECKED	-	JV	REVISED -
	PLOT DATE = 10/20/2023	DATE	-	10/13/2023	REVISED -

PROPOSED COLLECTOR STREET LIGHTING	N/A RTE.	SECTION	N	COUNTY	TOTAL SHEETS	SHEET NO.
PROPOSED LIGHTING PLAN	N/A	N/A		соок	24	6
THO OULD EIGHTING TEAM				CONTRACT	NO.	N/A
SCALE: 1" = 40' SHEET 2 OF 6 SHEETS STA. TO STA.		ILLI	INOIS FED.	. AID PROJECT		

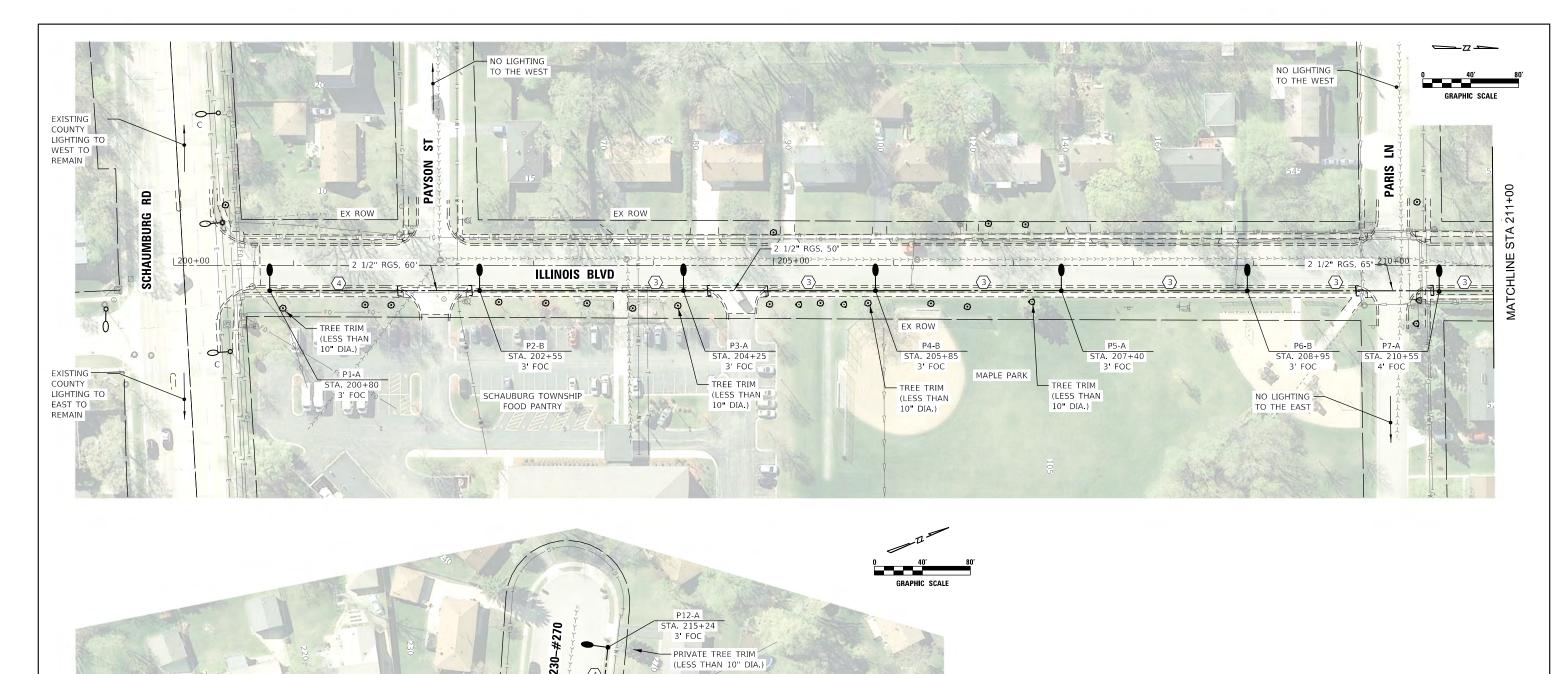

NOTES:

- 1. PROPOSED CONDUIT SHALL BE BORED AND PULLED TO MINIMIZE DISTURBANCE TO EXISTING LANDSCAPE AREAS.
- 2. NO CONSTRUCTION SHALL BEGIN ALONG ILLINOIS BOULEVARD UNTIL AFTER JULY 8, 2024. ILLINOIS BOULEVARD IS THE PARADE ROUTE FOR THE VILLAGE'S 4TH OF JULY EVENT.
- 3. CONTRACTOR SHALL COORDINATE TREE TRIMMING WITH THE VILLAGE PRIOR TO BEGINNING ANY WORK.
- 4. LIGHT POLES SHALL BE INSTALLED 4 FT BEHIND THE FACE OF CURB (FOC), ON CENTER, WHERE POSSIBLE.
- 5. PLANS WERE PREPARED BASED ON AVAILABLE UTILITY ATLAS INFORMATION. CONTRACTOR SHALL FIELD VERIFY UTILITY CONFLICTS.

	PROPOSED LIGHTING CABLE AND CONDUIT SCHEDULE
	ELECTRIC CABLE IN CONDUIT, 600V, 3-1/C #2 IN UNDERGROUND CONDUIT, GALV STEEL, 2 1/2" DIA.
2	UNIT DUCT, 600V, 4-1/C #4, 1/C #4 GROUND, (XLP-TYPE USE), 1 1/2" DIA. POLYETHYLENE
(3)	UNIT DUCT, 600V, 4-1/C #6, 1/C #6 GROUND, (XLP-TYPE USE), 1 1/4" DIA. POLYETHYLENE
4	UNIT DUCT, 600V, 2-1/C #6, 1/C #6 GROUND, (XLP-TYPE USE), 1 1/4" DIA. POLYETHYLENE
(5)	UNIT DUCT, 600V, 4-1/C #8, 1/C #8 GROUND, (XLP-TYPE USE), 1" DIA. POLYETHYLENE

10.00			
<i>(1)</i>	USER NAME = Electrical	DESIGNED - KL	REVISED -
Cìorba Group		DRAWN - MLB	REVISED -
8725 W. Higgins Rd, Ste 600, Chicago, IL 60631	PLOT SCALE = 80.0000 ' / in.	CHECKED - JV	REVISED -
P 773.775.4009 www.ciorba.com	PLOT DATE = 10/20/2023	DATE - 10/13/2023	REVISED -

P8-B

STA. 212+25

4' FOC

2 1/2" RGS, 40' +

P9-A STA. 214+00

4' FOC

P10-B

3' FOC

TA. 213+75

PRIVATE TREE TRIM

(LESS THAN 10" DIA.)

SECTION COUNTY PROPOSED COLLECTOR STREET LIGHTING COOK PROPOSED LIGHTING PLAN CONTRACT NO. SCALE: 1" = 40' SHEET 3 OF 6 SHEETS STA. TO STA.

24

VILLAGE OF HOFFMAN ESTATES

P13-A

STA. 217+15

4' FOC

ILLINOIS BLVD

P11-B


STA. 215+55


4' FOC


TREE TRIM

(LESS THAN

10" DIA.)

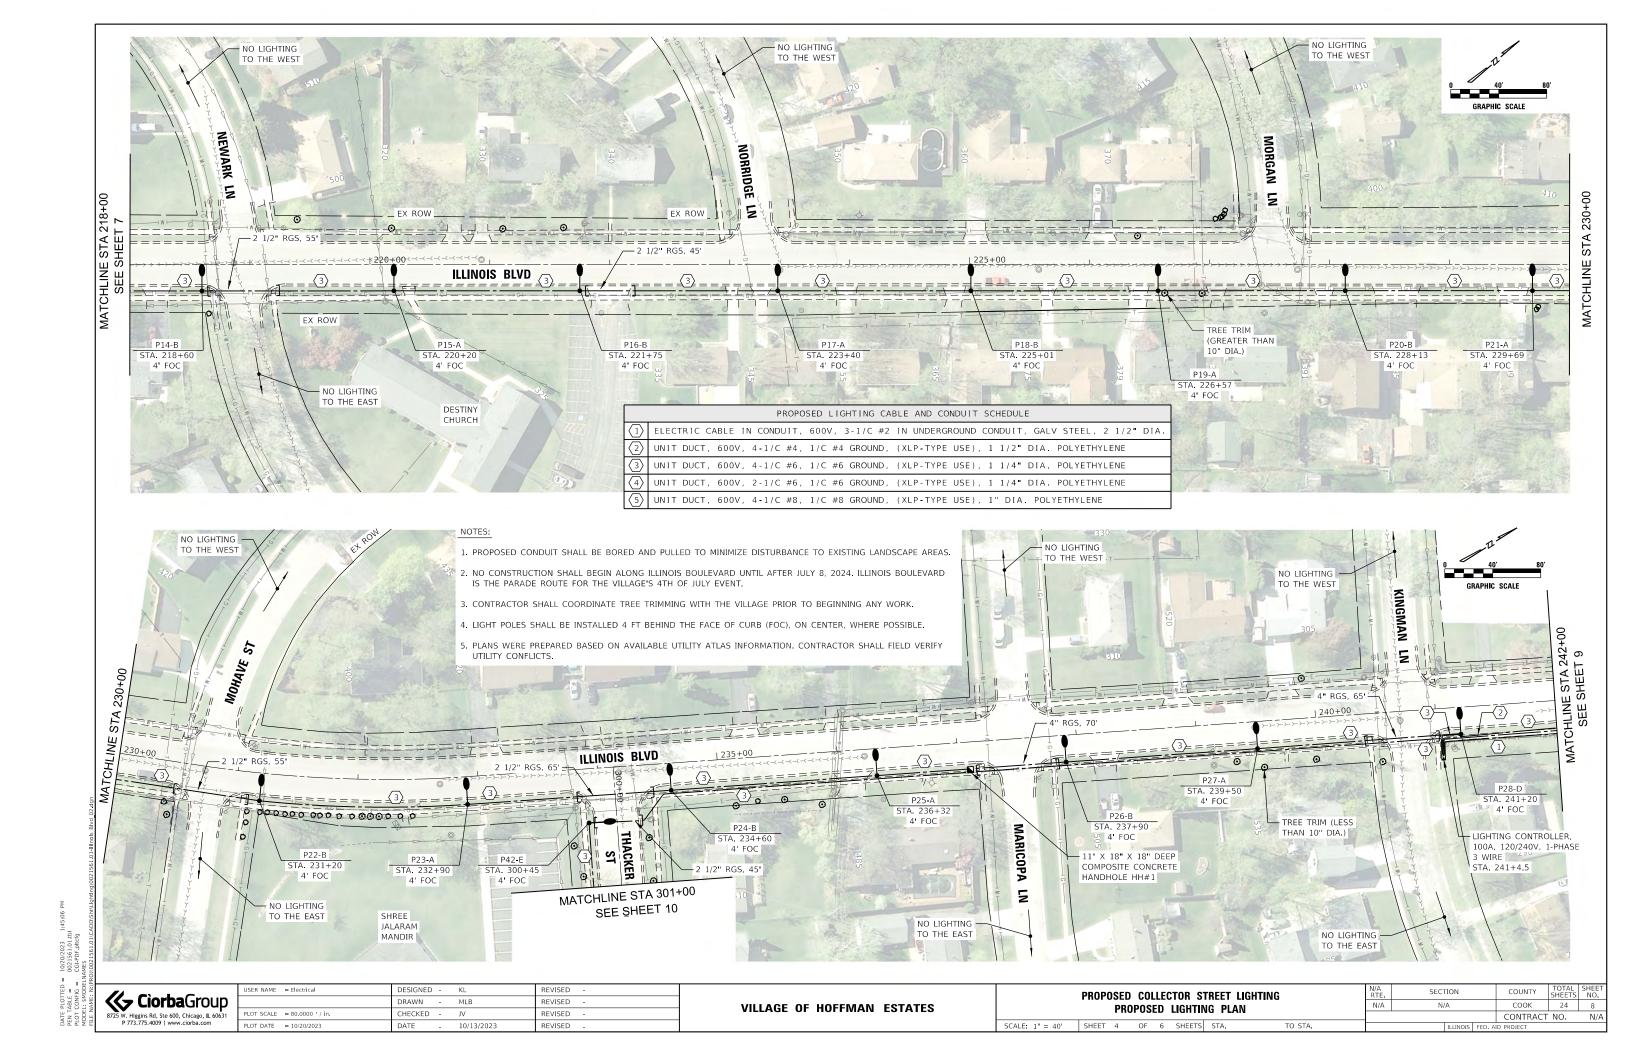

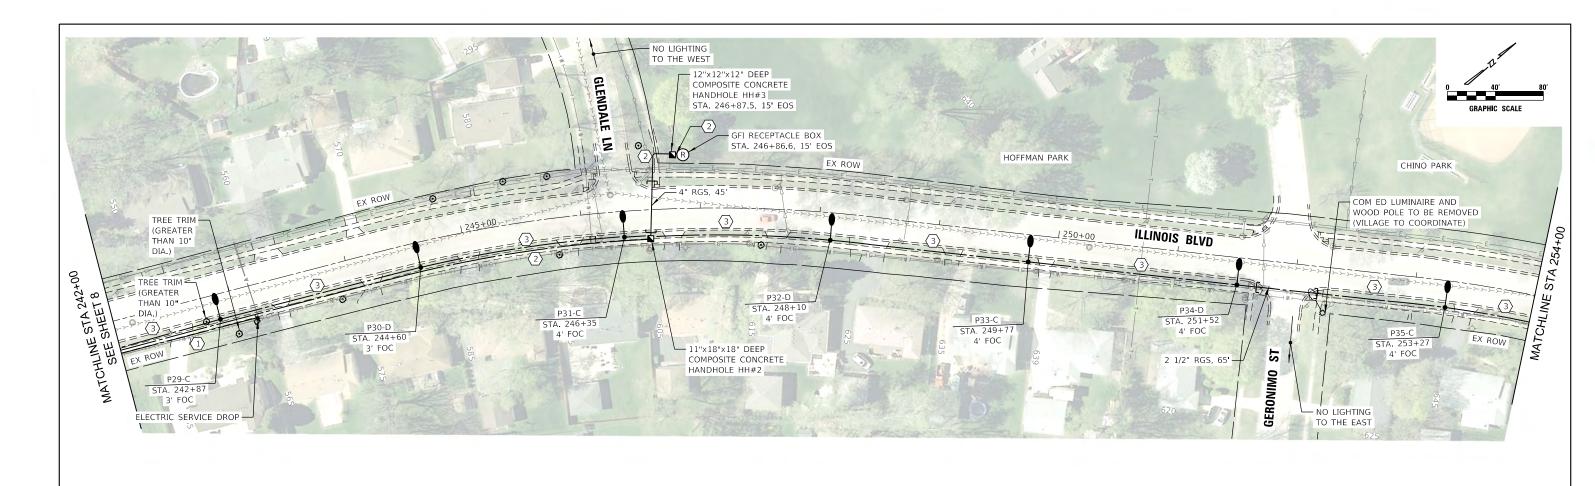

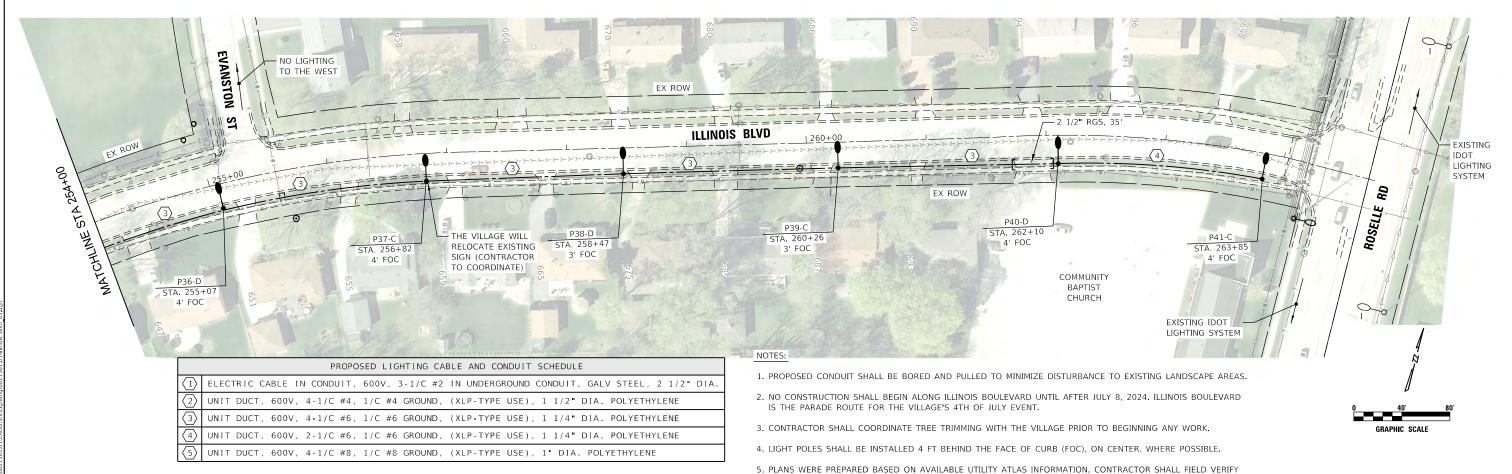

DATE PLOTTED = 10/20/2023 1:45:12 PM
PEN TABLE = 002156:0.1th
PLOT CONFIG = CGLPPF.pltCg
MODEL, SMODELNAMES

VILLAGE OF HOFFMAN ESTATES PROPOSI


UTILITY CONFLICTS.


PROPOSED COLLECTOR STREET LIGHTING
PROPOSED LIGHTING PLAN

SCALE: 1" = 40' SHEET 5 OF 6 SHEETS STA. TO STA.

N/A SECTION COUNTY SHEETS NO.
N/A N/A COOK 24 9
CONTRACT NO. N/A

SCALE: 1 = 40' SHEET 5 OF 6 SHEETS STA. TO STA.

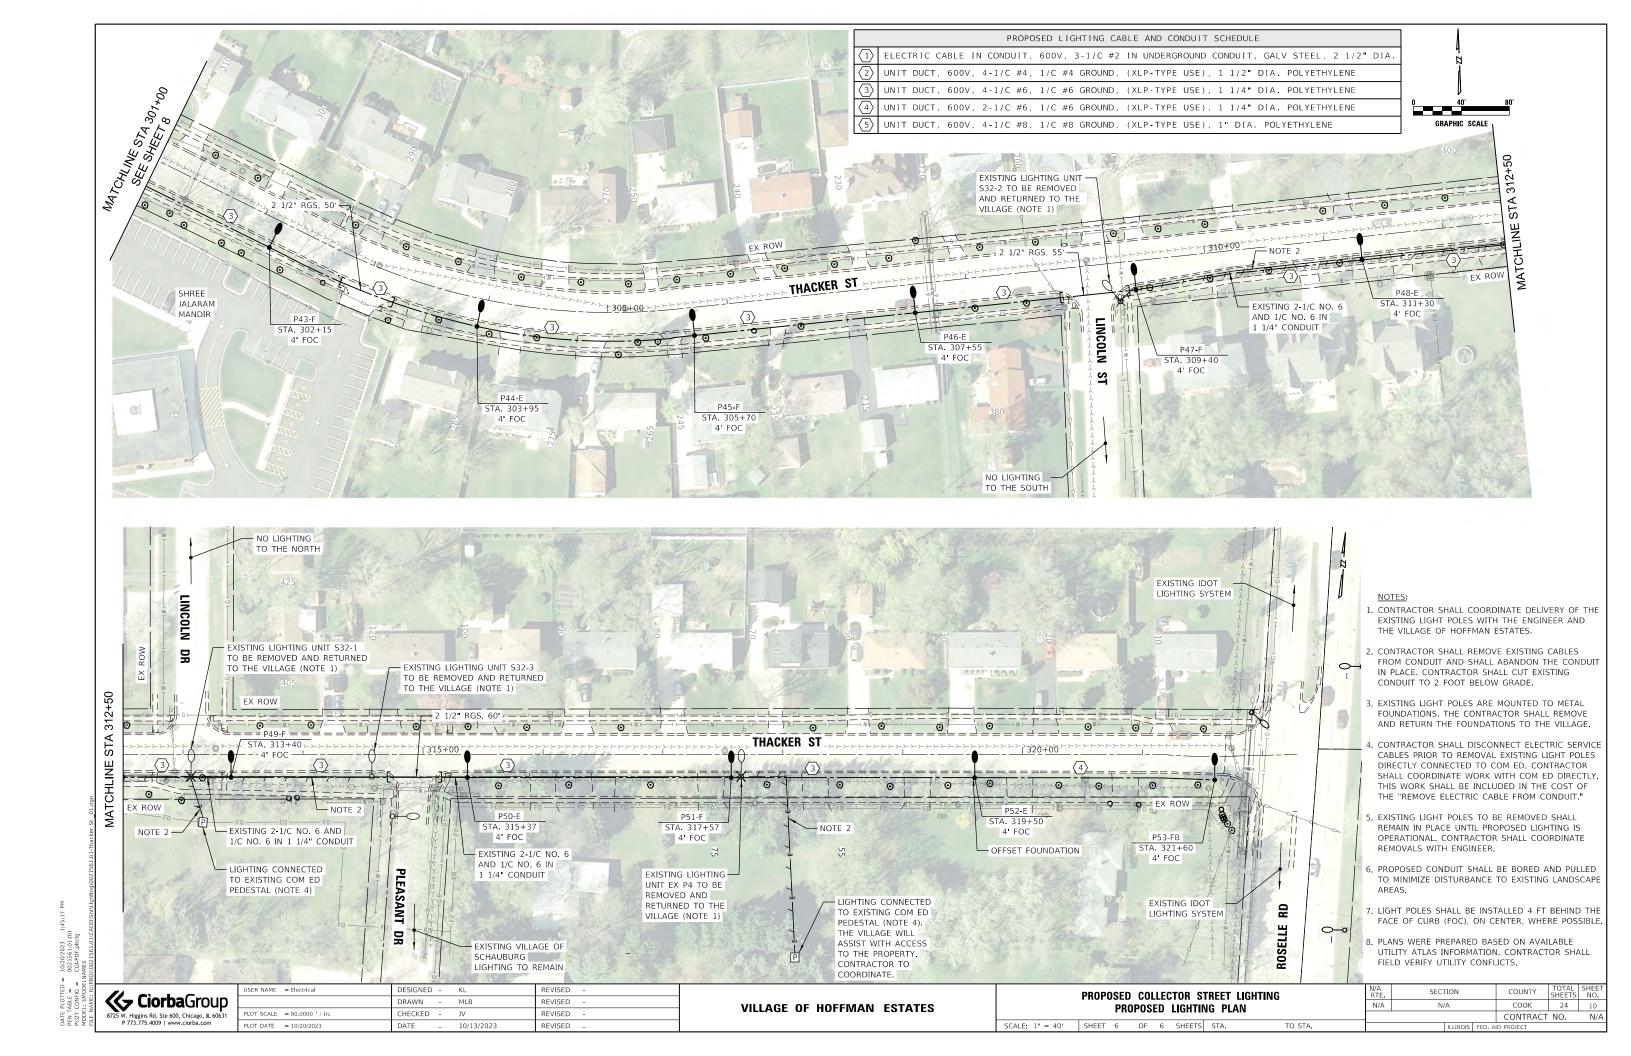

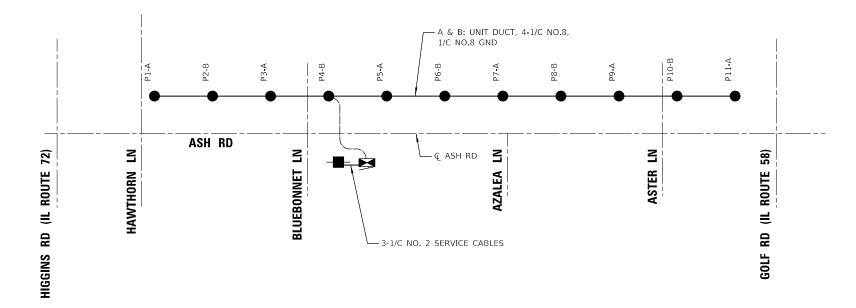

VILLAGE OF HOFFMAN ESTATES

ONE-LINE LEGEND

PROPOSED LIGHT POLE

PROPOSED BASE MOUNTED LIGHTING CONTROLLER

PROPOSED ELECTRIC SERVICE DROP

------ PROPOSED CABLE IN DUCT

CALL-OUT LEGEND




PROPOSED LIGHTING CONTROLLER LOAD TABLE						
CIRCUIT ID (INSULATION COLOR)	CIRCUIT BREAKER/ POLES	LED ROADWAY LUMINAIRE		TOTA	L CIRCUIT LO	AD
		QTY.	LOAD/FIXT (WATTS)	WATTS	AMPS	VOLTS
ROADWAY LIGHTING						
A - RED	30A-2P	6	118	708	3.0	240
B - BLACK	30A-2P	5	118	590	2.5	240
C - RED	30A-2P	0	118	0	0.0	240
D - BLACK	30A-2P	0	118	0	0.0	240
SPARE	30A-2P	0	118	0	0.0	240
SPARE	30A-2P	0	118	0	0.0	240
TOTAL 11				1298W	5.41A	

Cìorba Group
8725 W. Higgins Rd, Ste 600, Chicago, IL 60631
P 773.775.4009 www.ciorba.com

USER NAME = Electrical	DESIGNED -	KL	REVISED -	
	DRAWN -	MLB	REVISED -	
PLOT SCALE = 100.0000 ' / in.	CHECKED -	JV	REVISED -	
PLOT DATE = 10/20/2023	DATE -	10/13/2023	REVISED -	

RTE.	SEC ⁻	ΓΙΟΝ	COUNTY	SHEETS	NO.	
N/A	N,	COOK	24	11		
			CONTRACT	NO.	N/A	
		ILLINOIS	FED. A	ID PROJECT		

DATE PLOTTED = 10/20/2023 1:45:22 PM
PEN TABLE = 0021561.01.tbl
PLOT CONTING = CGI-PDF.pitcfg
MODEI: \$AMODEI = NAMES

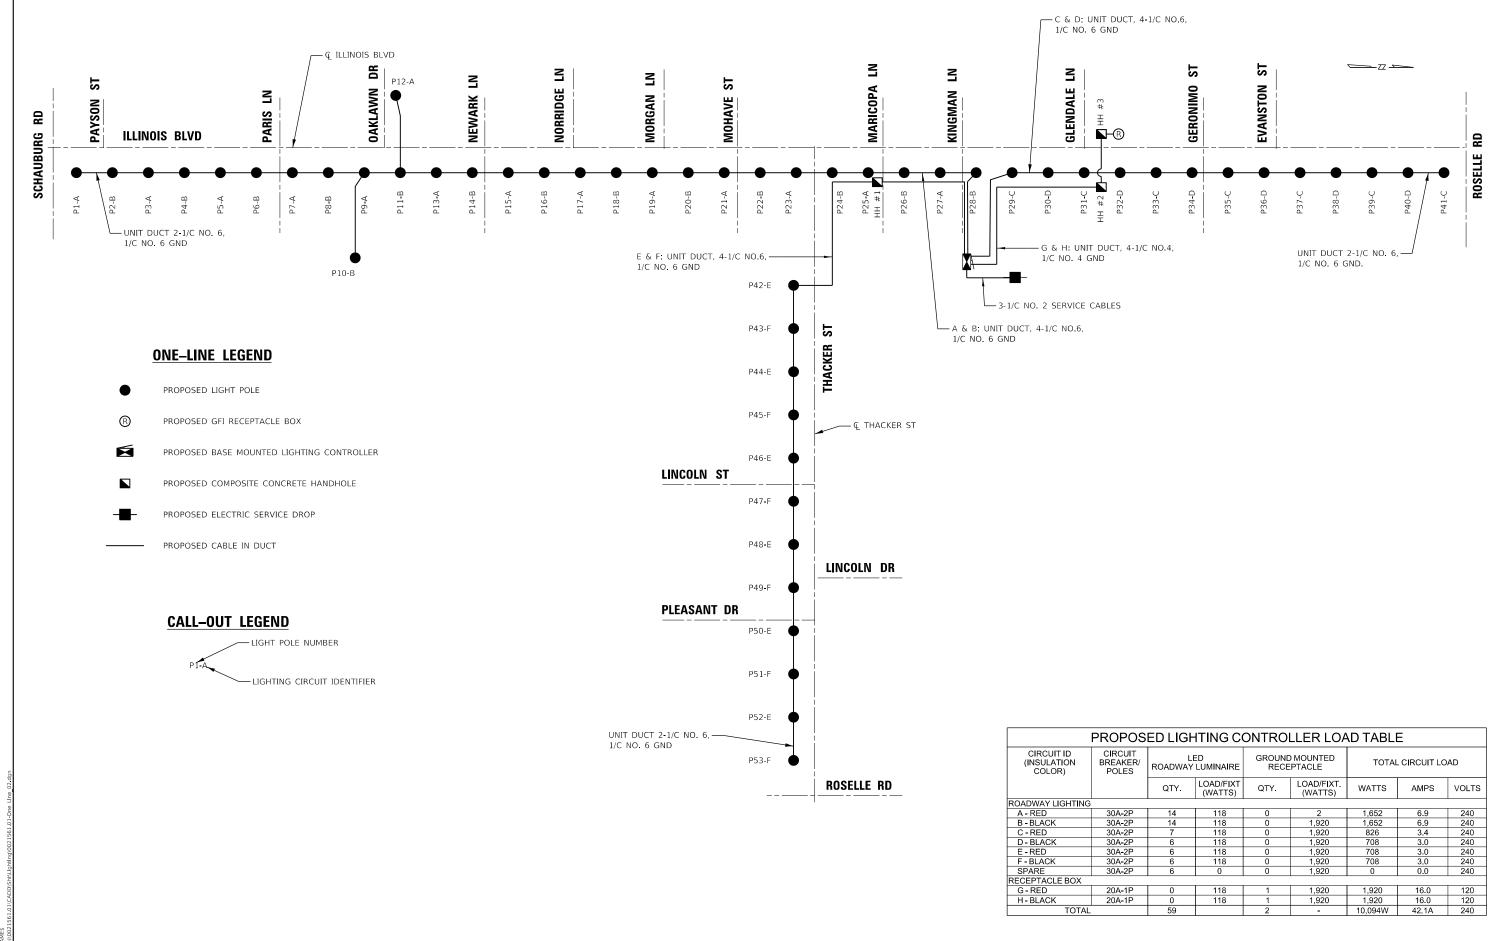

DATE PLOTIED = 10/20/2023 1:43:
PEN TABLE = 0021561.01.bl
PLOT CONFIG = CGI-PDF.pltcfg
MODEL: \$MODELNAME\$
FILE NAME: N:PROJ/0021561.01/CADD*

VILLAGE OF HOFFMAN ESTATES

PROPOSED COLLECTOR STREET LIGHTING

ILLINOIS BLVD & THACKER ST LIGHTING CONTROLLER ONE—LINE DIAGRAM

SCALE: N.T.S. SHEET 2 OF 2 SHEETS STA. TO STA.

N/A SECTION COUNTY STREET SHEETS NO.


N/A N/A COOK 24 12

CONTRACT NO. N/A

ASH ROAD LIGHTING CONTROLLER EQUIPMENT

TEN	I	QUANTITY	SPECIFICATION			
Α	MAIN CIRCUIT BREAKER	1	100A, 2P, 240V SERVICE RATING, 22KAIC			
В	CONTROL CIRCUIT BREAKER	1	15A, 1P, 120V RATING, 22KAIC			
С	CABINET CIRCUIT BREAKER	1	20A, 1P, 120V RATING, 22KAIC			
D	AUXILIARY RELAY	1	30A-120 V OPERATED DPDT 60 HZ COIL 2 NO & 2 NC CONTACTS, PLUG IN TYPE			
Ε	LIGHTING CONTACTOR	1	100A, 2-POLE, 120V COIL, MECHANICALLY HELD, OPEN TYPE			
_	CABINET RECEPTACLE AND BOX	1	COMMERCIAL GRADE GFCI 20A/120V, MOUNTED IN A WEATHERPROOF CAST ALUMINUM			
Г	CABINET RECEPTACLE AND BOX	1	TWO GANG BOX WITH WEATHERPROOF COVER			
G DOOR SWITCH 1 20A/120V, DOOR MOUNTED, SNAP ACTION PLUNGER SWITCH		20A/120V, DOOR MOUNTED, SNAP ACTION PLUNGER SWITCH				
Н	CABINET LIGHT	1	60W EQUIVALENT LED STRIP LIGHT, 60K HOUR RATING, FASTENED TO TOP OF CABINET			
1	BRANCH CIRCUIT BREAKERS	6	30A, 2P,240V RATING, 22 KAIC			
J	HAND-AUTO-OFF CONTROL SWITCH	1	20A, 3 POSITION MOUNTED IN 2-GANG CAST ALUMINUM BOX			
K	SURGE ARRESTOR	1	10 K AMPERE RATING			
L	POWER DISTRIBUTION BLOCK	1	600 VOLT, INSULATED, SIZE AS REQUIRED, 22KA			
			MIN 16 COPPER TERMINATIONS (#1/0-#10) WITH 4 SPARES, HORIZONTALLY MOUNTED,			
М	GROUND & NEUTRAL BUS BAR	2	AND HEADS OF SCREWS PAINTED WHITE FOR NEUTRAL BUS BAR AND GREEN FOR			
			GROUND BUS BAR			
N	PHOTOCELL TERMINAL BLOCK	1	3 TERMINAL, SCREW TYPE, #14-#10 WIRE SIZE			
Р	PHOTOCELL	1	120V, MOUNTED TO CABINET OVERHANG, DELAY TYPE, SPST-NC			
R	R UTILITY METER SOCKET 1 100A, 1-PHASE, 4 TERMINALS, CECHA APPROVED		100A, 1-PHASE, 4 TERMINALS, CECHA APPROVED			


- 1. THE CONTROLLER, ALONG WITH ALL ITS COMPONENTS, SHALL BE UL LISTED 508A AS AN "ENCLOSED INDUSTRIAL CONTROL PANEL."
- 2. THE MAIN CIRCUIT BREAKER SHALL BE LABELED "SERVICE DISCONNECT."
- 3. ALL SWITCHES SHALL BE IDENTIFIED USING TWO COLOR ENGRAVED NAME PLATES.
- 4. THE CABINET SHALL BE LABELED WITH THE APPROPRIATE ARC FLASH LABEL AND INCLUDE PERSONNEL PROTECTION DESIGNATIONS.
- . ALL EXPOSED BUS BARS AND COMPONENTS SHALL BE INSULATED.
- 6. CONTROL WIRE SHALL BE #12 MTW.
- POWER WIRES SHALL BE RHH/RHW, 600V, SIZE AS INDICATED ON THE PLANS.

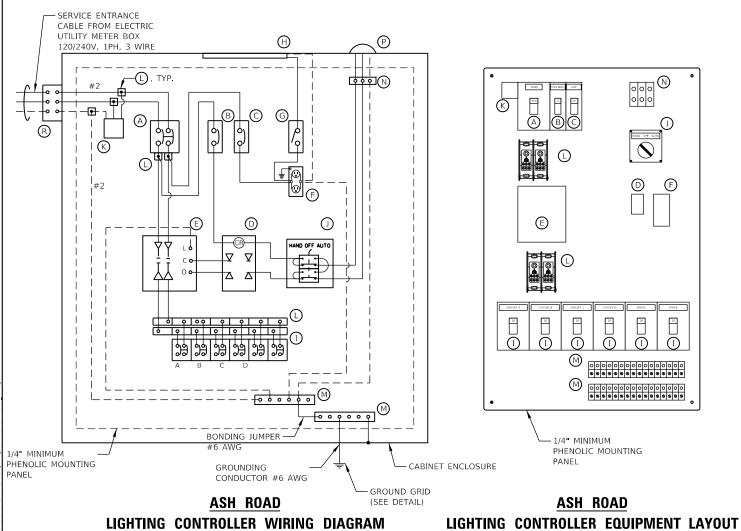

12"X12"X12" DEEP GREEN POLYMER CONCRETE ACCESS WELL WITH "GROUND" LOGO ENGRAVED IN COVER. TYP OF 3 QUAZITE OR APPROVED EQUAL NO. 6 BARD COPPER GROUND WIRE (TYP. EACH LEG) --- NO. 6 COPPER GROUND WIRE TO GROUND BUS EXOTHERMIC WELD GROUND 5/8"x10' COPPERCLAD WIRE TO GROUND ROD. GROUND ROD MIN. 1'-0' (NOTE 2) BELOW GRADE BE MOUNTED ON SIDE CLOSEST

NOTES:

- 1. ACCESS WELL SHALL BE INCLUDED IN THE LIGHTING CONTROLLER PAY ITEM.
- 2. CONTRACTOR SHALL COORDINATE NUMBER AND ORIENTATION OF CONNECTIONS REQUIRED IN EACH ACCESS WELL.

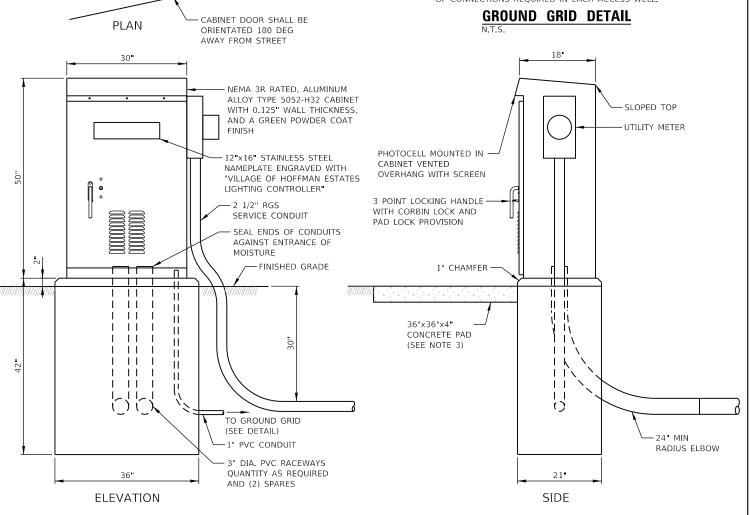

NOTES:

STREET SIDE

1. CABINET DIMENSIONS SHOWN ARE APPROXIMATE. CABINET SHALL BE AS COMPACT AS POSSIBLE.

UTILITY METER SHALL

TO ELECTRIC SERVICE DROP (CONTRACTOR TO COORDINATE)

- 2. FOUNDATION SIZE SHALL BE COORDINATED WITH CABINET SIZE AND MANUFACTURER'S RECOMMENDATIONS.
- 3. CONTRACTOR SHALL REMOVE VEGETATION IN FRONT OF CONTROL CABINET DOOR, LEVEL THE AREA AND TOP WITH 2" TOPSOIL. WHERE THERE IS NO SIDEWALK, INSTALL A CONCRETE PAD. THE COST OF LABOR AND MATERIALS ARE INCLUDED IN THE COST OF THE CONTROLLER.
- 4. ALL ITEMS SHOWN (INCLUDING FOUNDATION, RACEWAYS, GROUND GRID) SHALL BE INCLUDED IN THE "LIGHTING CONTROLLER BASE MOUNTED, 100A, 240VOLT" PAY ITEM. THE SERVICE CONDUIT AND CABLE SHALL BE PAID FOR SEPARATELY.

ASH ROAD LIGHTING CONTROLLER CABINET DETAIL



	USER NAME = Electrical	DESIGNED -	-	KL	REVISED -
)		DRAWN -	-	MLB	REVISED -
31	PLOT SCALE = 40.0000 ' / in.	CHECKED -	-	JV	REVISED -
	PLOT DATE = 10/20/2023	DATE -	-	10/13/2023	REVISED -


VILLAGE OF HOFFMAN ESTATES SCALE: N.T.S.

PROPO	SED	COL	LEC	CTOR ST	REET	LIGHTING	N/A RTE.	SECTION	COUNTY	TOTAL SHEETS	SHEET NO.
LIGHTING DETAILS					N/A	N/A	соок	24	13		
		LIGI		IG DEI	1120				CONTRACT	ΓNO.	N/A
SHEET	1	OF	7	SHEETS	STA.	TO STA.		ILLINOIS FED	AID PROJECT		

ILLINOIS BOULEVARD LIGHTING CONTROLLER EQUIPMENT

TEN	1	QUANTITY	SPECIFICATION				
Α	MAIN CIRCUIT BREAKER	1	100A, 2P, 240V SERVICE RATING, 22KAIC				
В	CONTROL CIRCUIT BREAKER	1	15A, 1P, 120V RATING, 22KAIC				
С	C CABINET CIRCUIT BREAKER 1		20A, 1P, 120V RATING, 22KAIC				
D	D AUXILIARY RELAY		30A-120 V OPERATED DPDT 60 HZ COIL 2 NO & 2 NC CONTACTS, PLUG IN TYPE				
Ε	E LIGHTING CONTACTOR		100A, 2-POLE, 120V COIL, MECHANICALLY HELD, OPEN TYPE				
F	F CABINET RECEPTACLE AND BOX		COMMERCIAL GRADE GFCI 20A/120V, MOUNTED IN A WEATHERPROOF CAST ALUMINUM TWO				
「	CABINET RECEPTACLE AND BOX	1	GANG BOX WITH WEATHERPROOF COVER				
G	DOOR SWITCH	1	20A/120V, DOOR MOUNTED, SNAP ACTION PLUNGER SWITCH				
Н	H CABINET LIGHT		60W EQUIVALENT LED STRIP LIGHT, 60K HOUR RATING, FASTENED TO TOP OF CABINET				
Т	BRANCH CIRCUIT BREAKERS	7	30A, 2P,240V RATING, 22 KAIC				
J	RECEPTACLE CIRCUIT BREAKERS	2	2A, 1P,240V RATING, 22 KAIC				
K	HAND-AUTO-OFF CONTROL SWITCH	1	20A, 3 POSITION MOUNTED IN 2-GANG CAST ALUMINUM BOX				
L	SURGE ARRESTOR	1	10 K AMPERE RATING				
М	POWER DISTRIBUTION BLOCK	AS REQ'D	600 VOLT, INSULATED, SIZE AS REQUIRED, 22KA				
N	N GROUND & NEUTRAL BUS BAR		MIN 16 COPPER TERMINATIONS (#1/0-#10) WITH 4 SPARES, HORIZONTALLY MOUNTED, AND HEADS OF SCREWS PAINTED WHITE FOR NEUTRAL BUS BAR AND GREEN FOR GROUND BUS BAR				
Р	P PHOTOCELL TERMINAL BLOCK		3 TERMINAL, SCREW TYPE, #14-#10 WIRE SIZE				
R	PHOTOCELL 1		120V, MOUNTED TO CABINET OVERHANG, DELAY TYPE, SPST-NC				
S	S UTILITY METER SOCKET 1		100A, 1-PHASE, 4 TERMINALS, CECHA APPROVED				
NOT	TES:						


- 1. THE CONTROLLER, ALONG WITH ALL ITS COMPONENTS, SHALL BE UL LISTED 508A AS AN "ENCLOSED INDUSTRIAL CONTROL PANEL."
- THE MAIN CIRCUIT BREAKER SHALL BE LABELED "SERVICE DISCONNECT."
- 3. ALL SWITCHES SHALL BE IDENTIFIED USING TWO COLOR ENGRAVED NAME PLATES.
- 4. THE CABINET SHALL BE LABELED WITH THE APPROPRIATE ARC FLASH LABEL AND INCLUDE PERSONNEL PROTECTION DESIGNATIONS.
- 5. ALL EXPOSED BUS BARS AND COMPONENTS SHALL BE INSULATED.
- 6. CONTROL WIRE SHALL BE #12 MTW.
- 7. POWER WIRES SHALL BE RHH/RHW, 600V, SIZE AS INDICATED ON THE PLANS.

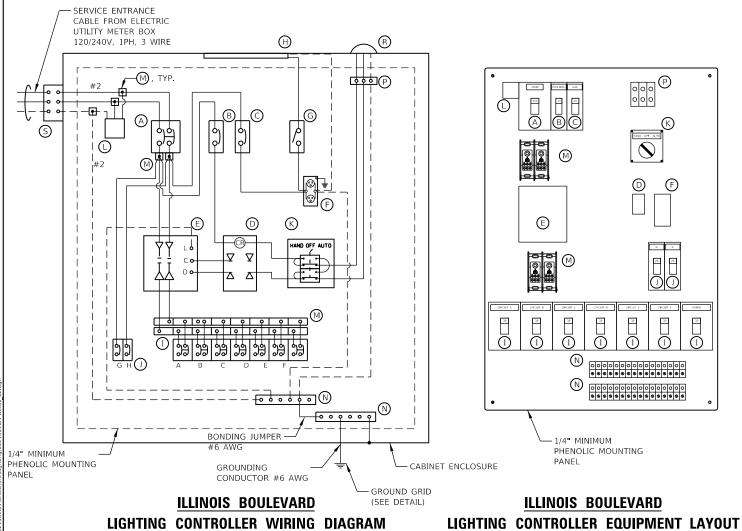

12"X12"X12" DEEP GREEN POLYMER CONCRETE ACCESS WELL WITH "GROUND" LOGO ENGRAVED IN COVER. TYP OF 3 QUAZITE OR APPROVED EQUAL NO. 6 BARD COPPER GROUND WIRE (TYP. EACH LEG) --- NO. 6 COPPER GROUND WIRE TO GROUND BUS EXOTHERMIC WELD GROUND 5/8"x10' COPPERCLAD WIRE TO GROUND ROD. GROUND ROD MIN. 1'-0" (NOTE 2) UTILITY METER SHALL BELOW GRADE BE MOUNTED ON SIDE CLOSEST NOTES: TO ELECTRIC SERVICE DROP (CONTRACTOR TO COORDINATE) 1. ACCESS WELL SHALL BE INCLUDED IN THE LIGHTING CONTROLLER PAY ITEM.

2. CONTRACTOR SHALL COORDINATE NUMBER AND ORIENTATION OF CONNECTIONS REQUIRED IN EACH ACCESS WELL.

GROUND GRID DETAIL

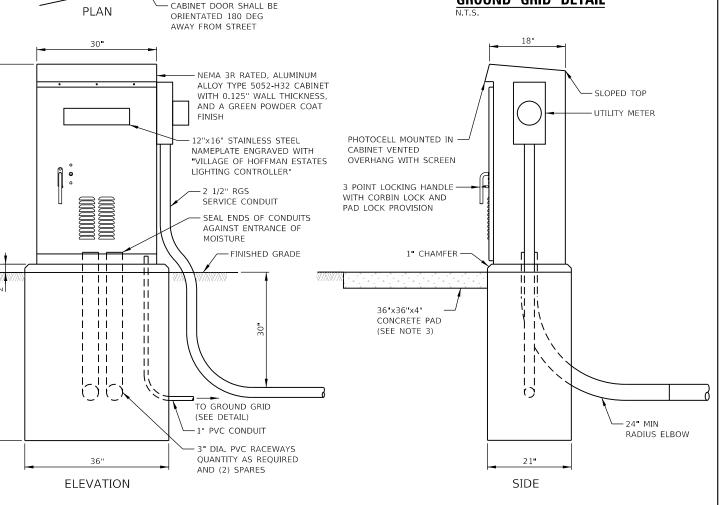

NOTES:

STREET SIDE

- 1. CABINET DIMENSIONS SHOWN ARE APPROXIMATE. CABINET SHALL BE AS COMPACT AS POSSIBLE.
- 2. FOUNDATION SIZE SHALL BE COORDINATED WITH CABINET SIZE AND MANUFACTURER'S RECOMMENDATIONS.
- CONTRACTOR SHALL REMOVE VEGETATION IN FRONT OF CONTROL CABINET DOOR, LEVEL THE AREA AND TOP WITH 2" TOPSOIL. WHERE THERE IS NO SIDEWALK, INSTALL A CONCRETE PAD. THE COST OF LABOR AND MATERIALS ARE INCLUDED IN THE COST
- 4. ALL ITEMS SHOWN (INCLUDING FOUNDATION, RACEWAYS, GROUND GRID) SHALL BE INCLUDED IN THE "LIGHTING CONTROLLER BASE MOUNTED, 100A, 240VOLT" PAY ITEM. THE SERVICE CONDUIT AND CABLE SHALL BE PAID FOR SEPARATELY.


ILLINOIS BOULEVARD LIGHTING CONTROLLER CABINET DETAIL



USER NAME = Electrical	DESIGNED -	-	KL	REVISED -
	DRAWN -	-	MLB	REVISED -
PLOT SCALE = 40.0000 / in.	CHECKED -	-	JV	REVISED -
PLOT DATE = 10/20/2023	DATE -	-	10/13/2023	REVISED -


VILLAGE OF HOFFMAN ESTATES SCALE: N.T.S.

PROPOSED COLLECTOR STREET LIGHTING					N/A RTE. SECTION		COUNTY	TOTAL SHEETS	SHEET NO.		
	LIGH	HTIN	IG DET	ΔIIS		N/A	N/A		соок	24	14
			IG DEI	1120					CONTRACT	NO.	N/A
SHEET 2	OF	7	SHEETS	STA.	TO STA.		ILLINO	S FED. A	ID PROJECT		

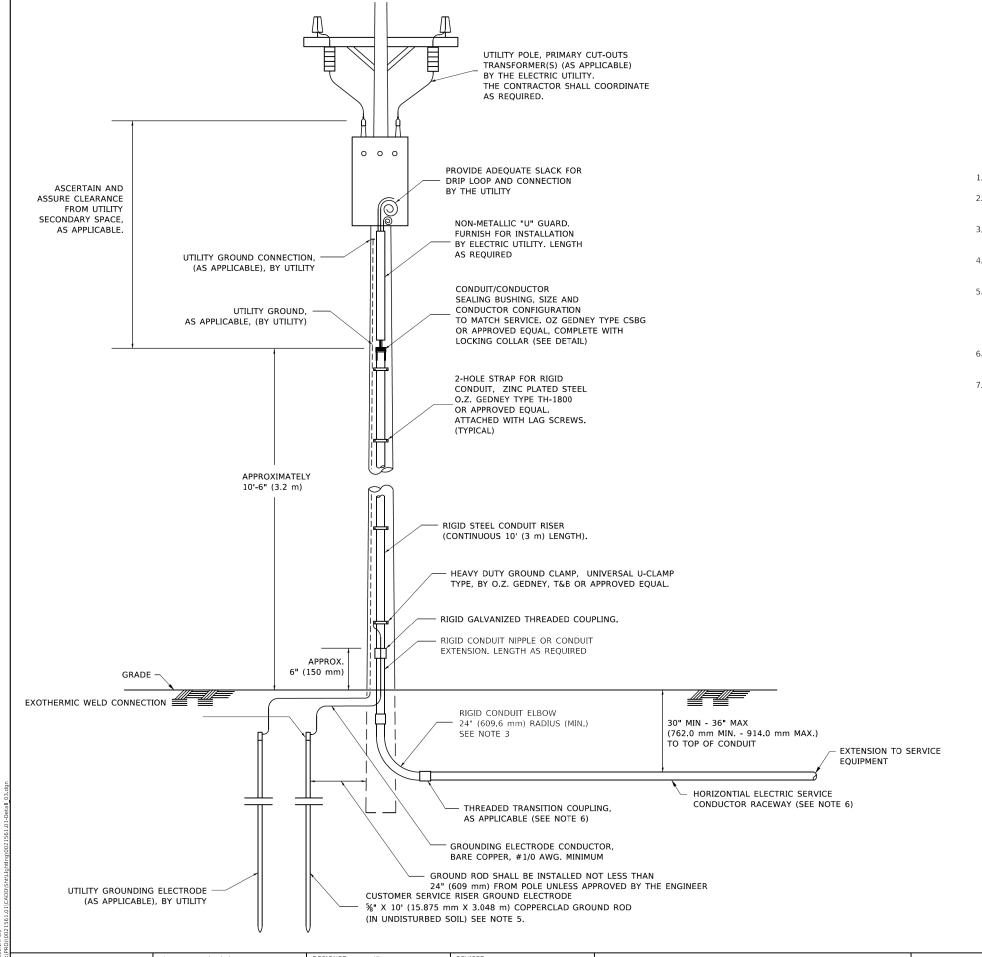

NOTES

- 1. SERVICE VOLTAGE SHALL BE AS INDICATED ELSWHERE IN THE DRAWINGS.
- 2. UNLESS OTHERWISE INDICATED, ITEMS AND WORK SHALL BE INCLUDED AND PAID AS PART OF THE ELECTRIC UTILITY SERVICE INSTALLATION PAY ITEM.
- 3. CONDUIT AND CONNECTOR DIAMETER SHALL MATCH THE DIAMETER OF THE SERVICE CONDUCTOR RACEWAY AS INDICATED ON THE PLANS.
- 4. ALL WORK SHALL CONFORM TO COM ED'S BOOK OF "INFORMATION AND REQUIREMENTS FOR THE SUPPLY OF ELECTRIC SERVICE".
- 5. THE CONTRACTOR SHALL OBTAIN INSPECTION AND APPROVAL BY THE VILLAGE ELECTRICAL INSPECTOR OF SERVICE RISER GROUND ELECTRODE, RISER ELBOW, NIPPLE AND CONNECTION TO SERVICE CONDUCTOR RACEWAY EXTENSION BEFORE BACKFILL AND SHALL ALSO OBTAIN INSPECTION OF SERVICE RISER AND SEALING BUSHING BEFORE UTILITY "U" GUARD INSTALLATION AND SERVICE CONNECTION.
- 6. THE HORIZONTAL ELECTRIC SERVICE CONDUCTOR RACEWAY SHALL BE AS INDICATED AND SHALL BE MEASURED SEPARATELY FOR PAYMENT.
- 7. PLANS AND DETAILS INDICATE THE GENERAL NATURE AND REQUIREMENTS. THEY DO NOT SHOW EVERY ACCESSORY AND ATTACHMENT, AND THEY DO NOT RELIEVE THE CONTRACTOR OF THE REQUIREMENTS OF THE SPECIFICATIONS AND SPECIAL PROVISIONS TO ASCERTAIN UTILITY REQUIREMENTS AND TO COORDINATE ACCORDINGLY. FURNISHING ALL ITEMS AND WORK NOT PROVIDED BY THE UTILITY, BUT NECESSARY FOR A COMPLETE SERVICE INSTALLATION IS REQUIRED AND SHALL BE INCLUDED IN THE ELECTRIC UTILITY SERVICE INSTALLATION PAY ITEM.

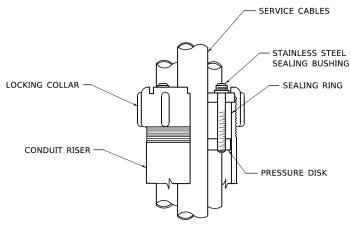

SEALING BUSHING DETAIL

ĕ	
ź	- 4
ij	Cìorba Group
NAME:	Cioi badi oup
щ	8725 W. Higgins Rd, Ste 600, Chicago, IL 60631
Ξ	P 773.775.4009 www.ciorba.com


	USER NAME = Electrical	DESIGNED -	KL	REVISED -
ם		DRAWN -	MLB	REVISED -
31	PLOT SCALE = 100.0000 ' / in.	CHECKED -	JV	REVISED -
	PLOT DATE = 10/20/2023	DATE -	10/13/2023	REVISED -


VILLAGE OF HOFFMAN ESTATES

SCALE: N.T.S.

PROPOSED COLLECTO	R STREE	r LIGHTING	N/A RTE.	SECTION	COUNTY	TOTAL SHEETS	SHEET NO.
LIGHTING	DETAILS		N/A	N/A	соок	24	15
Lidiiilid	DETAILE				CONTRACT	ΓNO.	N/A
CUEET 2 OF 7 CI	IFFTS STA	TO STA		WARRIED SED	ALD DOOLEGE		

BLE = 0021561.01.fbl ONFIG = CGI-PDF.ptcfg : \$MODELNAME\$

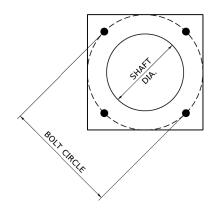

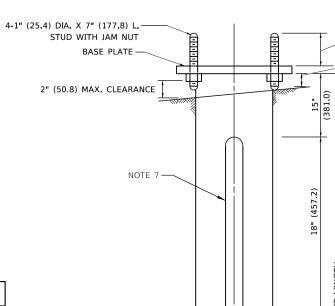

(63.5)

HELIX FOUNDATION SIZE

POLE MOUNTING HEIGHT	BOLT CIRCLE	SHAFT DIAMETER	SHAFT LENGTH	BASEPLATE
30 FT.	11½"	8%"	6 FT.	12"x12"x1"
31 FT35 FT.	11½"	8%"	6 FT.	12"x12"x1"
36 FT40FT.	15"	8%"	6 FT.	15"x15"x1¼"
41 FT45 FT.	15"	8%"	6 FT.	15"x15"x1¼"
46 FT50 FT.	15"	10"	8 FT.	15"x15"x1¼"

METAL HELIX FOUNDATION MATERIALS

ITEM	MATERIAL REQUIREMENT
BASEPLATE	AASHTO M 270M, GRADE 36 (M270M, GRADE 250)
SHAFT	ASTM A 252, GRADE 2 (PHOSPHOROUS 0.04% MAXIMUM, SULFUR 0.05% MAXIMUM)
HELIX SCREW	AASHTO M 183 (ASTM A 635)
PILOT POINT	AASHTO M 270 (ASTM A 575)
ANCHOR RODS/STUDS	AASHTO M 314 (ASTM F 1554)
HEXAGON NUTS	AASHTO M 291M (ASTM A 563) GRADE DH, OR AASHTO M 292 (ASTM A 194) GRADE 2H
WASHERS	AASHTO M 293 (ASTM F 436)



RIGID CONDUIT NIPPLE OR CONDUIT EXTENSION. LENGTH AS REQUIRED

1½" (31.75) DIA.

SHAFT DIA.

NOTES

- 1. ALL DIMENSION IN INCHES (MILLIMETERS) UNLESS OTHERWISE SHOWN.
- 2. ALL MATERIAL SHALL BE GALVANIZED ACCORDING TO AASHTO M111, UNLESS OTHERWISE SPECIFIED.
- 3. ALL WELDS SHALL BE CONTINUOUS AND NOT LESS THAN 1/4" (6.35 mm) FILLET WELDS. THE WELDED FOUNDATION SHALL BE CAPABLE OF WITHSTANDING 10,000 FT/LBS (13558.18 n.m) OF INSTALLATION TORQUE APPLIED ABOUT THE AXIS OF THE FOUNDATION.
- 4. THE HELIX FOUNDATION SHAFT SHALL BE INSTALLED VERTICAL AND THE BASE PLATE SHALL BE LEVEL. THE BREAKAWAY COUPLINGS AND HARDWARE SHALL NOT BE USED TO ALIGN THE POLE INSTALLATION.
- 5. THE CABLE TRENCH SHALL BE BACKFILLED AND FIRMLY COMPACTED BEFORE THE INSTALLATION OF THE LIGHT POLE.
- 6. THE CONTRACTOR SHALL COORDINATE EXTENSION OF ANCHOR BOLTS ABOVE TOP OF THE BASE PLATE WITH THE BREAKAWAY DEVICE MANUFACTURER'S REQUIREMENTS.

TO STA.

- 7. ANY VOIDS WITHIN THE METAL FOUNDATION SHALL BE FILLED WITH FINE AGGREGATE.
- 8. METAL FOUNDATIONS SHALL BE INSTALLED IN UNDISTURBED SOIL. PREDRILLING A PILOT HOLE AND/OR BACKFILLING AROUND THE FOUNDTION IS NOT ALLOWED.
- 9. THE METAL FOUNDATION SHALL NOT BE INSTALLED TO A TORQUE WHICH EXCEEDS THE MANUFACTURER'S MAXIMUM TORQUE RATING NOR SHALL IT BE INSTALLED TO AN INSTALLATION TORQUE VALUE OF LESS THAN 3,500 FT LB (4,750 KNM). METAL FOUNDATIONS THAT ARE NOT INSTALLED TO FULL INSTALLATION DEPTH OR DO NOT ACHIEVE THE MINIMUM INSTALLATION TORQUE SHALL BE REMOVED AND REPLACED WITH A CONCRETE FOUNDATION AT NO ADDITIONAL COST.
- 10. THE BASEPLATE SHALL BE PERPENDICULAR TO THE SHAFT AXIS (\pm 1 $^{\circ}$) AND THE HOLE CENTERLINE SHALL BE CONCENTRIC (\pm 0.188) TO THE SHAFT AXIS.
- 11. THE PILOT POINT AND SHAFT AXIS SHALL BE CONCENTRIC (± 0.125) AND IN LINE (± 2°).
- 12. THE BASEPLATE SHALL BE STAMPED WITH THE MANUFACTURERS NAME AND DATE OF MANUFACTURE.

8	
S.	7 4
NAME:	Cìorba Group
JIE.	8725 W. Higgins Rd, Ste 600, Chicago, IL 60631 P 773.775.4009 www.ciorba.com

USER NAME = Electrical	DESIGNED - KL	REVISED -
	DRAWN - MLB	REVISED -
PLOT SCALE = 100.0000 ' / in.	CHECKED - JV	REVISED -
PLOT DATE = 10/20/2023	DATE - 10/13/2023	REVISED -

	PROPOSED			TOR S G DET		LIGHTING
SCALE: N.T.S.	SHEET 4	OF	7	SHEETS	STA.	

N/A RTE.	SECTION			COUNTY	TOTAL SHEETS	SHE
N/A	N/A			COOK	24	16
				CONTRACT	NO.	N
		ILLINOIS	EED Δ	ID PROJECT		

NAME: NYPROJ/0021561.01/CAI

VILLAGE OF HOFFMAN ESTATES

- 0.25" WALL, MIN.

SEE NOTE NO. 6

MIN. CLEARANCE

FOUNDATION DESIGN TABLE

	DESIGN DEPTH (OF FOUNDATION	REINFORCEMENT IN FOUNDATION				
TYPE OF SOIL	SINGLE ARM	TWIN ARM	SINGLE	ARM	TWIN ARM		
	D	D	VERT BARS	SPIRAL	VERT BARS	SPIRAL	
SOFT CLAY	13'-0"	15'-0"	8-#6X12'-6"	#3X122'	8-#6X14'-3"	#3X141'	
	(3.962 m)	(4.572 m)	(3.810 m)	(37.186 m)	(4.343 m)	(42.977 m)	
MEDIUM CLAY	9'-6"	10'-9"	8-#6X9'-0"	#3X90'	8-#6X10'-0"	#3X100'	
	(2.896 m)	(3.277 m)	(2.743 m)	(27.432 m)	(3.048 m)	(30.480 m)	
STIFF CLAY	7'-0"	8'-0"	8-#6X6'-6"	#3X66'	8-#6X7'-6"	#3X76'	
	(2.134 m)	(2.438 m)	(1.981 m)	(20.112 m)	(2.286 m)	(23.165 m)	
LOOSE SAND	9'-0"	10'-0"	8-#6X8'-6"	#3X85'	8-#6X9'-6"	#3X94'	
	(2.743 m)	(3.048 m)	(2.591 m)	(25.908 m)	(2.896 m)	(28.651 m)	
MEDIUM SAND	8'-3"	9'-0"	8-#6X8'-0"	#3X78'	8-#6X8'-6"	#3X85'	
	(2.515 m)	(2.743 m)	(2.438 m)	(23.774 m)	(2.591 m)	(25.908 m)	
DENSE SAND	7'-9"	9'-0"	8-#6X7'-6"	#3X73'	8-#6X8'-6 "	#3X85'	
	(2.362 m)	(2.743 m)	(2.286 m)	(22.250 m)	(2.591 m)	(25.908 m)	
ROCK OR SOLIDIFIED SLAG	5'-0" (1.524 m)	5'-0" (1.524 m)	NONE	NONE	NONE	NONE	

OFFSET SCHEDULE


BILL OF MATERIAL

MARK	NO.	SIZE	LENGTH	SHAPE
a	10	6	SEE BELOW	_
s	12	4	8'-0" (2.438 m)	
s ₁	s ₁ 3		7'-6" (2.286 m)	
v ₁	8	6	2'-9" (0.838 m)	1
v ₂				

SEWER	PILE OFFSET	LENGTH of
DIAM. d	from Q-MED'N	BAR a
IN.	FT.	FT.
UP TO 24"	3'-3"	#6 x 5'-3"
(609.6 mm)	(0.991 m)	(1.600 m)
27" (685.8 m)TO	3'-9"	5'-9 "
36" (914.4 mm)	(1.143 m)	(1.753 m)
42" (1066.8 mm) TO	4'-6"	6'-6"
48" (1219.2 mm)	(1.372 m)	(1.981 m)
54" (1371.6 mm) TO	5'-0"	7'-0"
60" (1524.0 mm)	(1.524 m)	(2.134 m)
66" (1676.4 mm) TO	5'-6"	7'-6"
72" (1828.8 mm)	(1.676 m)	(2.286 m)

NOTES

- 1. ALL DIMENSIONS ARE IN INCHES (MILLIMETERS) UNLESS OTHERWISE SHOWN.
- 2. THE ENGINEER SHALL DETERMINE THE CLASS OF SOIL DURING EXCAVATION AND SELECT THE DESIGN DEPTH OF FOUNDATION FROM THE DESIGN TABLE.
- 3. EXCAVATION OF THE POLE FOUNDATION SHALL BE MADE WITH AN AUGER, 24" (609.6 mm) OR 30" (762.0 mm) IN DIAMETER.
- 4. THE ANCHOR ROD SHALL BE A HOOK ROD TYPE. COLD BENDING OF THE ANCHOR ROD WILL NOT BE ALLOWED. THE RADIUS OF THE HOOK BEND SHALL NOT BE LESS THAN 4 TIMES THE NOMINAL DIAMETER OF THE ANCHOR ROD. A TACK WELDED ANCHOR ROD MAY BE SUBSTITUTED WITH THE APPROVAL OF THE ENGINEER
- 5. THE ANCHOR BOLTS AND RACEWAYS SHALL BE PROPERLY SECURED IN PLACE BEFORE THE CONCRETE IS PLACED IN THE FORM.
- 6. THE ANCHOR RODS SHALL BE ACCORDING TO ASTM F1554 GRADE 725 (GRADE 105). NUTS SHALL BE HEXAGON NUTS ACCORDING TO ASTM A 194 2H OR ASTM A 563 DH, AND WASHERS SHALL BE ACCORDING TO ASTM F 436.
- 7. THE CONTRACTOR SHALL COORDINATE EXTENSION OF ANCHOR BOLTS ABOVE TOP OF FOUNDATION WITH THE BREAKAWAY DEVICE MANUFACTURER'S REQUIREMENTS. IF LIGHT POLE IS MOUNTED WITHOUT BREAKAWAY DEVICE, ANCHOR BOLTS SHALL PROJECT 2 3/4" (69.9 mm) ABOVE TOP OF THE FOUNDATION. THE CONTRACTOR SHALL CONFIRM ANCHOR BOLT EXTENTION WITH ENGINEER.
- 8. RACEWAYS SHALL PROJECT 1" (25.4 mm) ABOVE THE TOP OF THE FOUNDATION.
- 9. THE CABLE TRENCH SHALL BE BACKFILLED AND FIRMLY COMPACTED BEFORE THE LIGHT IS ERECTED.

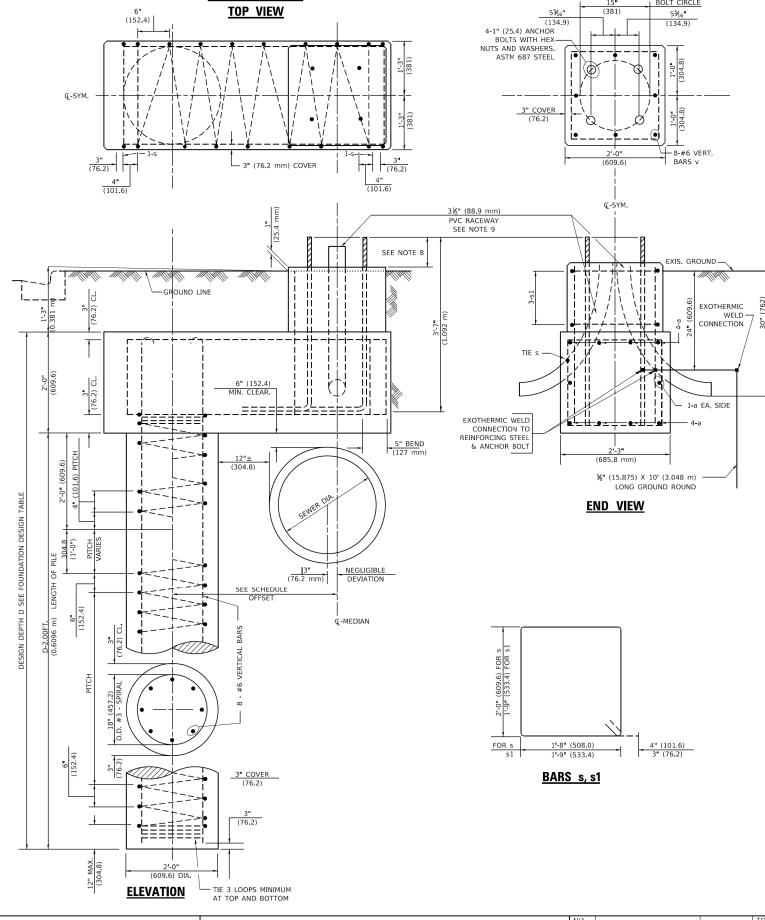


PLAN-CAP BEAM

W. Higgins Rd, Ste 600, Chicago, IL 60631 P 773.775.4009 | www.ciorba.com

SCALE: N.T.S.

TOP VIEW

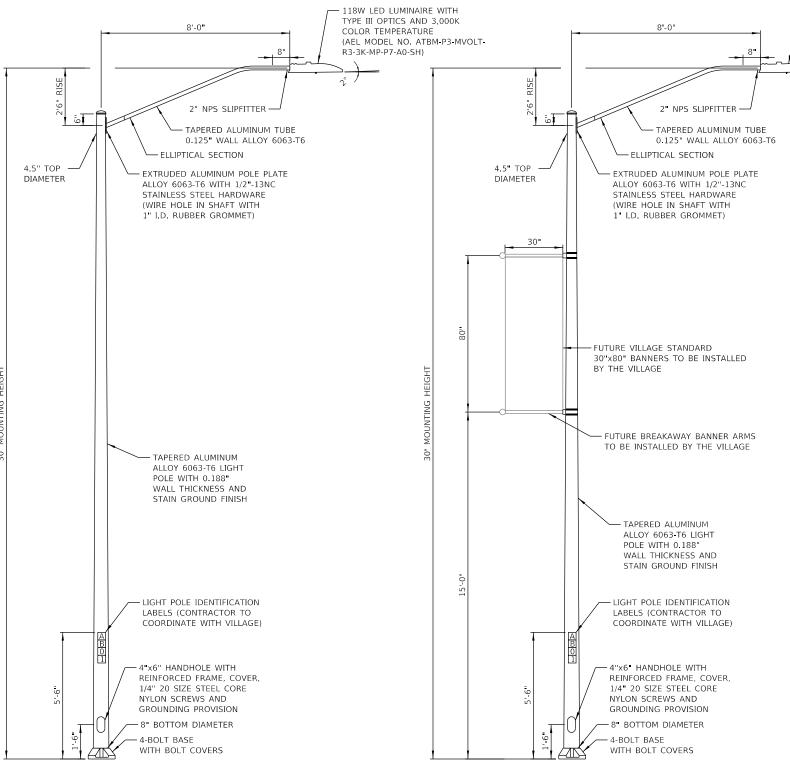

ASH ROAD AND THACKER STREET LIGHT POLE DETAIL N.T.S.

ILLINOIS BOULEVARD LIGHT POLE DETAIL N.T.S.

SCALE: N.T.S.

118W LED LUMINAIRE WITH

TYPE III OPTICS AND 3,000K

(AEL MODEL NO. ATBM-P3-MVOLT-

COLOR TEMPERATURE

R3-3K-MP-P7-A0-SH)

1. LUMINAIRE SHALL BE PROVIDED WITH 7-PIN TWISTLOCK RECEPTACLE AND SHORTING CAP.

BOLT HOLE FOR GROUNDING CONNECTOR

TRAFFIC FLOW

POSITION OF HANDHOLE AND

POLE NUMBER FOR SINGLE

MAST ARM POLES

LIGHT POLE BASE PLATE DETAIL

HANDHOLE DETAIL

(N.T.S.)

HANDHOLE POSITION - POLE SHAFT

1" ANCHOR BOLTS (SIZE IN ACCORDANCE WITH MFG REQUIREMENTS)

24 18

8" BASE DIA LIGHT POLE

— 11₫" BOLT CIRCLE

POLE SHAFT

ORIENTATION

BANNER ARM

(ILLINOIS BLVD ONLY)

LIGHT POLE IDENTIFIERS (CONTRACTOR TO COORDINATE WITH THE VILLAGE)


- 2. LUMINAIRE SHALL BE PAID FOR AT THE CONTRACT UNIT PRICE FOR "LUMINAIRE, LED, ROADWAY, OUTPUT DESIGNATION F.*
- 3, CONTRACTOR SHALL SUPPLY 15 HOUSE SIDE SHIELDS (AEL ATBMHSS) TO THE VILLAGE FOR INSTALLATION AT A FUTURE TIME. SHIELDS SHALL BE PAID FOR AT THE CONTRACT UNIT PRICE FOR "LUMINAIRE SHIELD".
- 4. THE LIGHT POLE SHALL MEET THE AASHTO DESIGN CRITERIA AS SPECIFIED.
- 5. LIGHT POLES SHALL NOT BE INSTALLED WITHOUT MAST ARMS AND LUMINAIRES.
- 6. LIGHT POLES SHALL BE SET PLUMB ON THE FOUNDATION WITHOUT THE USE OF LEVELING NUTS, WASHERS OR SHIMS.
- 7. LIGHTING UNIT IDENTIFICATION NUMBERS SHALL BE INSTALLED BEFORE THE LIGHTING UNIT IS ENERGIZED. THIS WORK SHALL BE COORDINATED WITH THE VILLAGE DURING CONSTRUCTION.
- 8. ILLINOIS BLVD LIGHT POLE WALL THICKNESS WAS DESIGNED BASED ON AASHTO DESIGN CRITERIA FOR THOSE POLE MOUNTED LOADS SHOWN ON THIS SHEET. ADDITIONAL LOADS SHALL REQUIRE ADDITIONAL CALCULATIONS.

CìorbaGroup W. Higgins Rd, Ste 600, Chicago, IL 60631 P 773.775.4009 | www.ciorba.com


JSER NAME = Electrical DESIGNED -REVISED DRAWN MLB REVISED REVISED LOT DATE = 10/20/2023 REVISED

VILLAGE OF HOFFMAN ESTATES

SECTION COUNTY PROPOSED COLLECTOR STREET LIGHTING COOK LIGHTING DETAILS CONTRACT NO. SHEET 6 OF 7 SHEETS STA. TO STA.

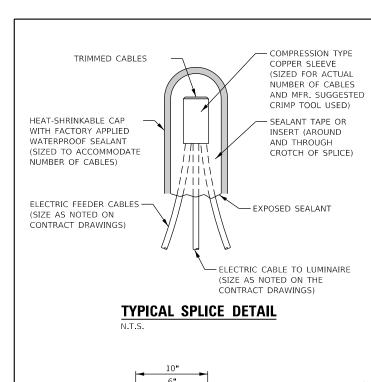


SECTION A-A

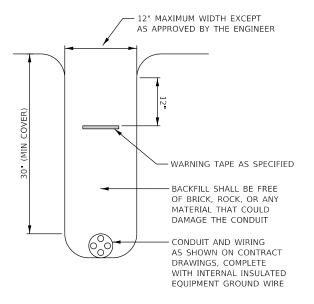

HANDHOLE SHALL BE PROVIDED WITH GASKET 3-1/C #10 AWG, 600V TYPE XLP-USE, SOLID STANDARD-TYPE SMALL COLOR CODED CABLES DIMENSION DOUBLE POLE, BREAKAWAY, FUSEHOLDER WITH INSULATED BOOTS AND FUSING (SEE SPECS) - CABLE SPLICE (TYP.) GROUNDING LUG-SPLICE GROUND WIRE AND PIGTAIL SAME SIZE EXTENSION TO POLE GROUNDING LUG PHASE CONDUCTORS, INSULATED GROUND 600 V TYPE XLP-USE, WIRE, 600V TYPE SOLID COLOR, SIZE AS XLP-USE SOLID COLOR SPECIFIED GREEN, SIZE AS SPECIFIED UNIT DUCT (TYP)

POLE WIRING DETAIL FOR

PROPOSED LIGHT POLES

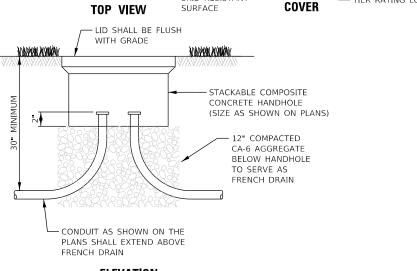

SKID RESISTANT

STAINLESS STEEL

WASHER

HEX HEAD BOLT AND

COVER SHALL BE BOLTED

ON THE PLANS

LIGHTING

AND HAVE "LIGHTING" LOGO

UNLESS OTHERWISE SHOWN

TIER RATING LOGO

ELEVATION

NOTES:

OPEN BOTTOM -

- 1. ALL SPLICES SHALL BE WATERPROOF (SEE SPLICING DETAIL THIS SHEET).
- POLYMER CONCRETE HANDHOLE AND LID SHALL BE GREEN IN LANDSCAPED AREAS AND MATCH COLOR IN CONCRETE/BRICK AREAS.
- 3. BOX & LID SHALL MEET/EXCEED ANSI TIER 15 LOADING REQUIREMENTS, AND BE TESTED IN ACCORDANCE WITH THE LATEST EDITION OF THE ANSI/SCTE 77 "SPECIFICATION FOR UNDERGROUND ENCLOSURE INTEGRITY", AND THE PROVISIONS OF PARAGRAPHS 5.2.3 AND 5.2.4 OF WESTERN UNDERGROUND COMMITTEE GUIDE 3.6.

COMPOSITE CONCRETE HANDHOLE DETAIL


N.T.S.

TYPICAL WIRING IN TRENCH DETAIL

N.T.S.

NOTES:

- 1. ENCLOSURE SHALL BE AS MANUFACTURED BY EXCEL, LTD. OR APPROVED EQUAL.
- 2. ALL FASTENERS AND HINGES SHALL BE STAINLESS STEEL.
- 3. CORD ACCESS DOOR SHALL BE SPRING LOAD AND SHALL PROVIDE IN-USE RATING WHILE LOADS ARE CONNECTED TO RECEPTACLES.
- 4. ALL ABOVE ITEMS INCLUDING CONCRETE FOUNDATION SHALL BE INCLUDED IN THE "GFI RECEPTACLE BOX, 120V" PAY ITEM.

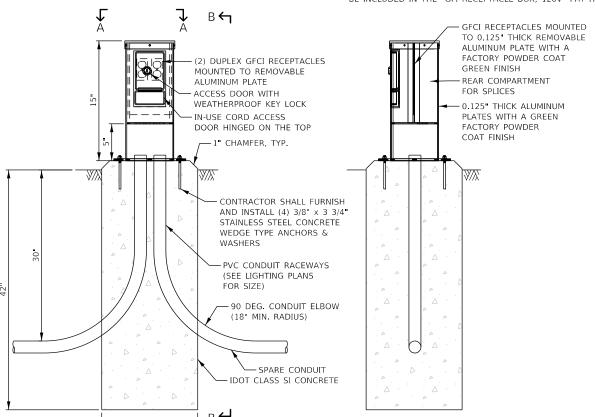

CUTOUT IN ALUMINUM

(2) L SHAPED ALUMINUM


BRACKETS WELDED IN 3

THE ENCLOSURE AND

SEALED WITH CAULK

PLACES ON EACH SIDE OF

PLATE FOR ACCESS TO SPLICES

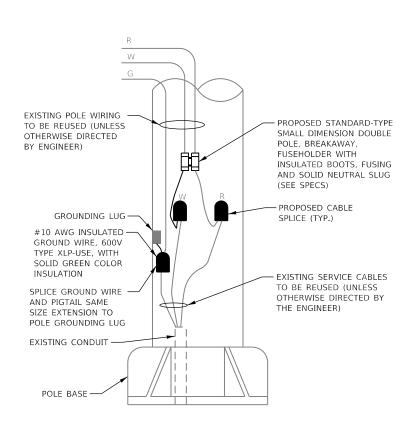

POLE WIRING DETAIL FOR
EXISTING LIGHT POLES

SCALE: N.T.S.

GFI RECEPTACLE BOX, 120V DETAIL

CìorbaGroup

8725 W. Higgins Rd, Ste 600, Chicago, IL 60631
P 773.775.4009 | www.ciorba.com

USER NAME = Electrical	DESIGNED -	REVISED -
	DRAWN -	REVISED -
PLOT SCALE = 100.0000 / in.	CHECKED -	REVISED -
PLOT DATE = 10/20/2023	DATE - 10/13/2023	REVISED -

SECTION B-B


VILLAGE OF HOFFMAN ESTATES


PROPOSED COLLECTOR STREET LIGHTING						LIGHTING	N/A RTE.	SECTION		COUNTY	TOTAL SHEETS	SHEET NO.	
LIGHTING DETAILS				N/A	N/A		соок	24	19				
LIGHTING DETAILS								CONTRACT	NO.	N/A			
SHI	EET	7	OF	7	SHEETS	STA.	TO STA.		ILLING	IS FED. A	ID PROJECT		


N.T.S.


15" DIA


N.T.S.

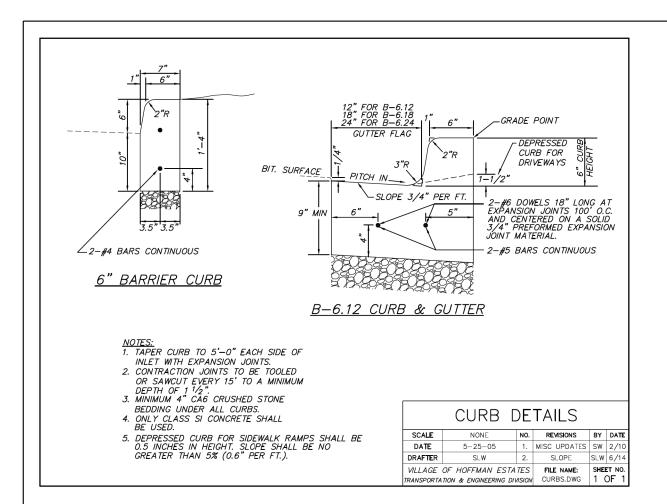

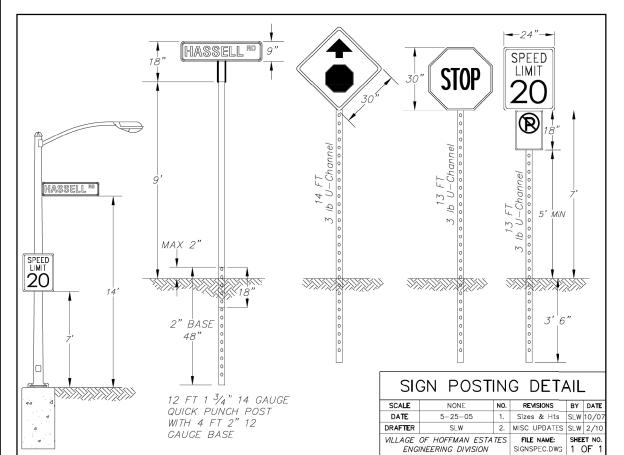

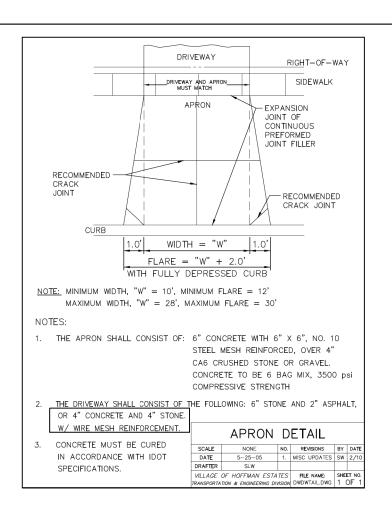

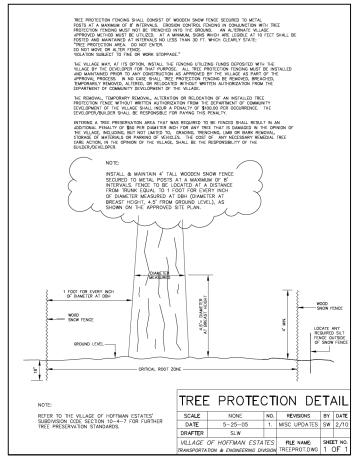

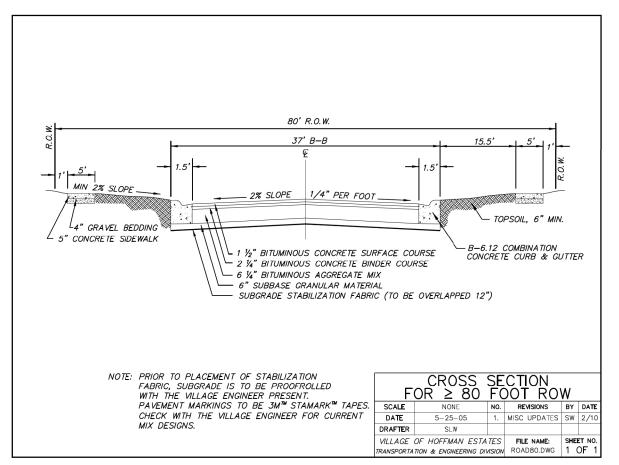




USER NAME = Electrical	DESIGNED -	KL	REVISED -
	DRAWN -	MLB	REVISED -
PLOT SCALE = 100.0000 ' / in.	CHECKED -	JV	REVISED -
PLOT DATE = 10/20/2023	DATE -	10/13/2023	REVISED -


PROPOSED COLLECTOR STREET LIGHTING **VILLAGE DETAILS** SCALE: N.T.S. SHEET 1 OF 1 SHEETS STA.


TO STA.


N/A RTE.	SECTION		COUNTY	TOTAL SHEETS	SHEE NO.
N/A	N/A	соок	24	20	
			CONTRACT	NO.	N/A
	ILLINOIS	EED. A	ID PROJECT		

VILLAGE OF HOFFMAN ESTATES

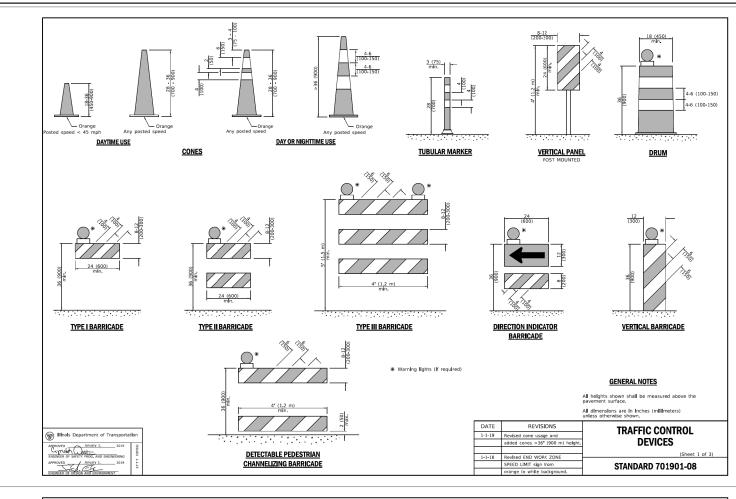

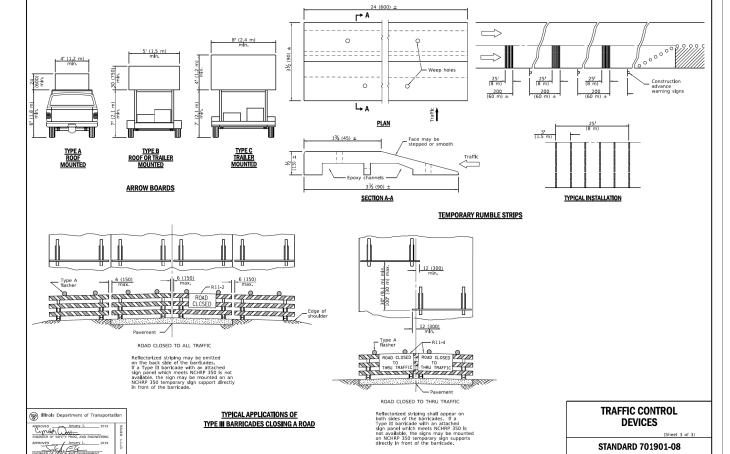

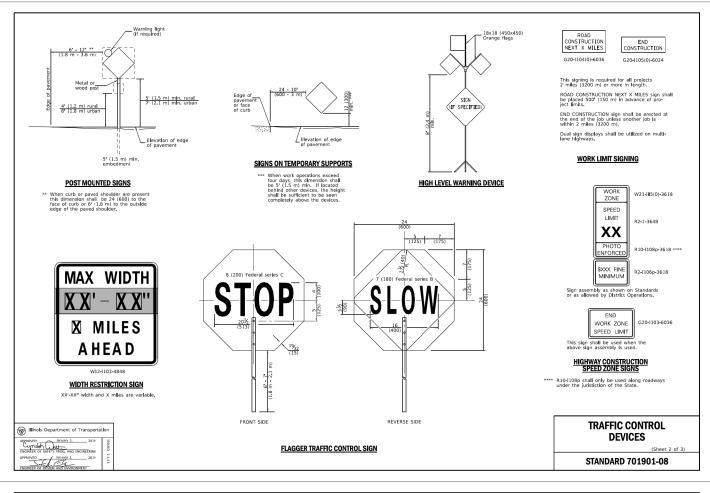

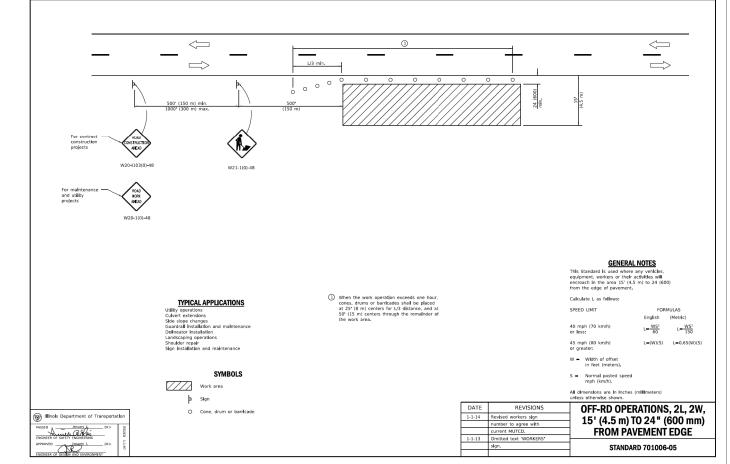



DESIGNED - KL REVISED DRAWN -MLB REVISED HECKED -REVISED 8725 W. Higgins Rd, Ste 600, Chicago, IL 60631 P 773.775.4009 | www.ciorba.com PLOT DATE = 10/20/2023 DATE 10/13/2023 REVISED


PROPOSED COLLECTOR STREET LIGHTING **MOT DETAILS** SHEET 1 OF 2 SHEETS STA. TO STA.


SCALE: N.T.S.


SECTION N/A COOK 24 21 CONTRACT NO.

CìorbaGroup

VILLAGE OF HOFFMAN ESTATES

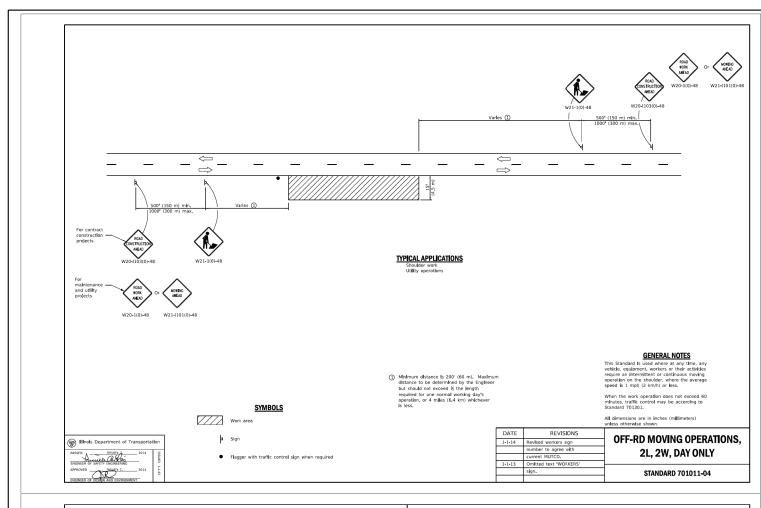

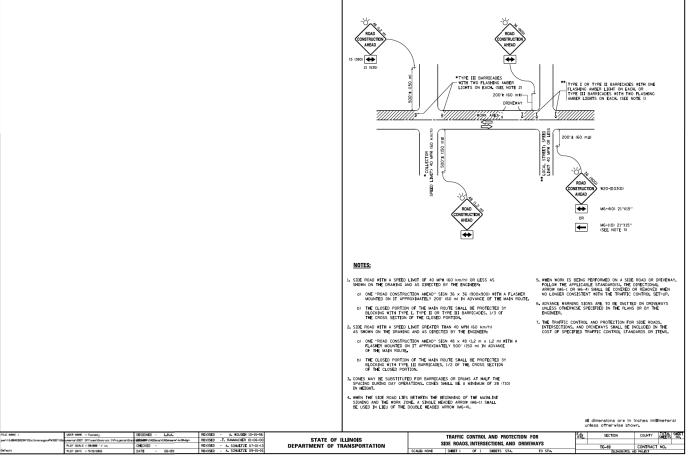

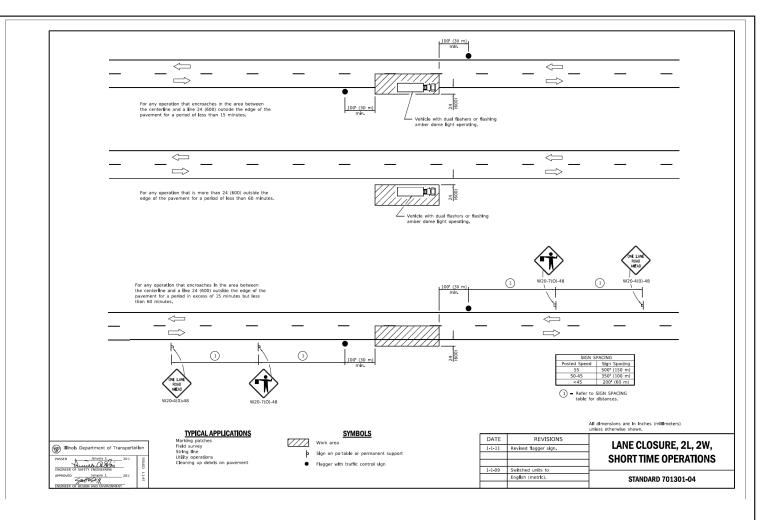


CìorbaGroup

8725 W. Higgins Rd, Ste 600, Chicago, IL 60631
P 773.775.4009 | www.ciorba.com


REVISED DRAWN -MLB REVISED LOT SCALE = 100.0000 ' / in. CHECKED -REVISED PLOT DATE = 10/20/2023 REVISED DATE 10/13/2023


VILLAGE OF HOFFMAN ESTATES


PROPOSED COLLECTOR STREET LIGHTING									SECTION	COUNTY	TOTAL SHEETS	SHEET NO.
MOT DETAILS							N/A	N/A	соок	24	22	
INOT DETAILS										CONTRACT	NO.	N/A
	SCALE: N.T.S.	SHEET 2	OF	2	SHEETS	STA.	TO STA.		ILLINOIS FED. A	ID PROJECT		

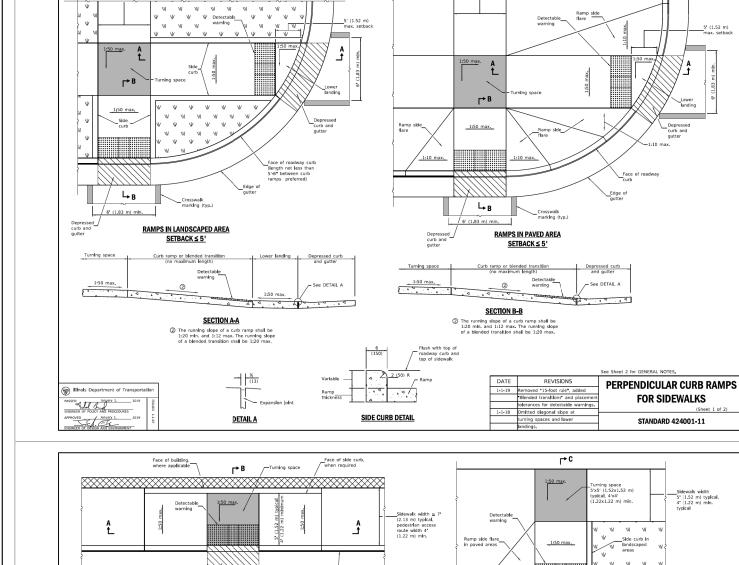

Sidewalk width 5' (1.52 m) typical, 4' (1.22 m) mln.

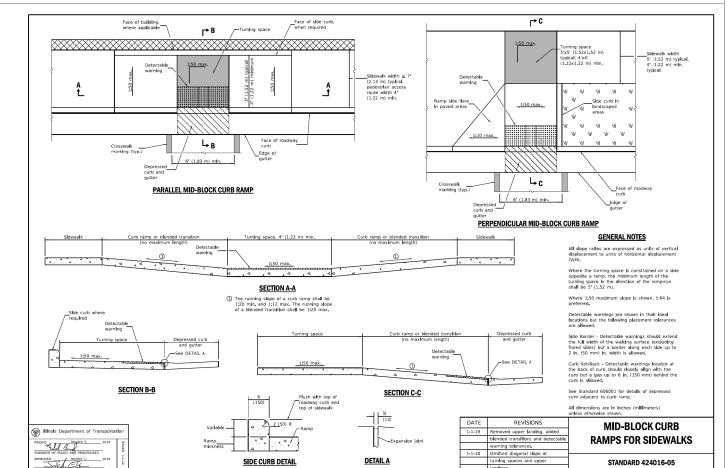

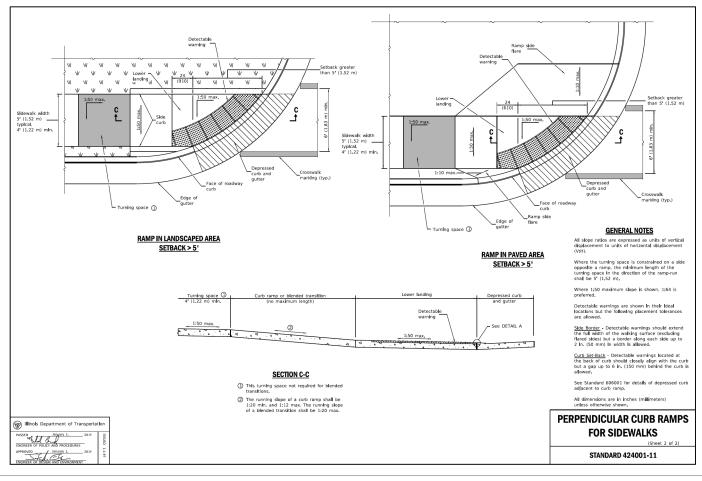

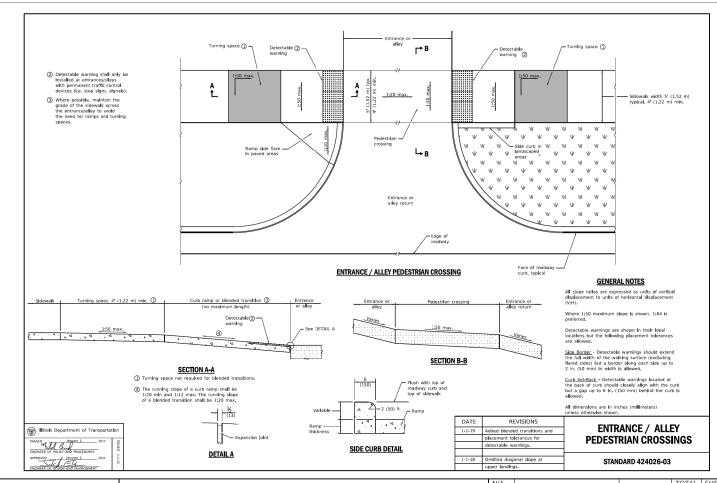

DATE PLOTTED = 10/20/2023 1:46:06 PM
PEN TABLE = 0021561.01.tbl
PLOT COMPG = CGI-PDF.pltcfg
MADDEL & MADDEL MANAGE


CiorbaGroup
8725 W. Higgins Rd, Ste 600, Chicago, IL 60631
P 773.775.4009 | www.ciorba.com

VILLAGE OF HOFFMAN ESTATES

PROPOSED COLLECTOR STREET LIGHTING
CIVIL DETAILS

SCALE: N.T.S. SHEET 1 OF 2 SHEETS STA. TO STA.

SECTION	COUNTY	TOTAL SHEETS	NO.	
A	N/A	COOK	24	23
CONTRACT	NO.	N/A		
ILLINOIS	FED. AID PROJECT			

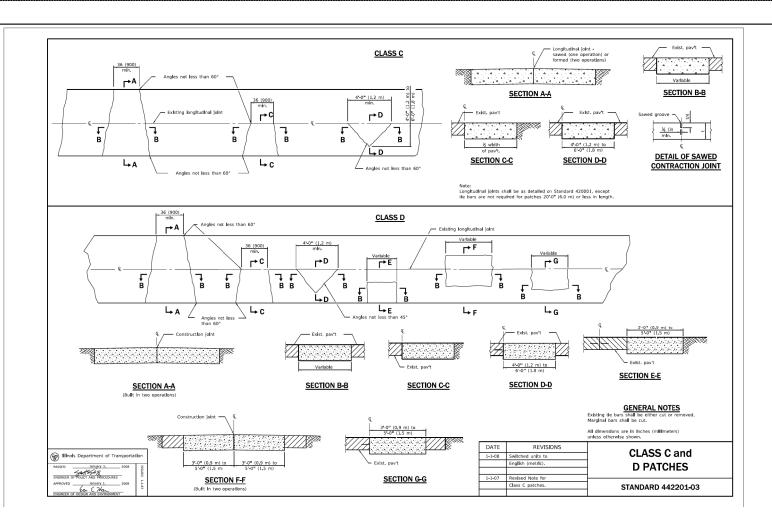

PR	
N:N	
	Clauba Cuana
Ξ	l <<> Ciorba Group
NAME	(A
щ	8725 W. Higgins Rd, Ste 600, Chicago, IL 60631
Ħ	P 773.775.4009 www.ciorba.com

	PROPOSED COLLECTOR STREET LIGHTING CIVIL DETAILS						
SCALE: N.T.S.	SHEET 2	OF	2	SHEETS	STA.	TO STA.	

N/A RTE.	SEC ⁻	ΓΙΟΝ		COUNTY	TOTAL SHEETS	SHEET NO.
N/A	N,	/Α	соок	24	24	
				CONTRACT	NO.	N/A
		ILLINOIS	ID PROJECT			

VILLAGE	ΩF	HOFFMAN	FSTATES
VILLAGE	vi	IIOI I IVIAIN	LOIAILO